

# ROOF REPLACEMENT & FACADE REPAIRS

5555 E OLIVE AVENUE, FRESNO, CA 93727



**ADOPTION / APPROVAL**

CONTRACT NUMBER: 24-S-08  
ADOPTED BY COUNTY OF FRESNO  
BOARD OF SUPERVISORS

\_\_\_\_\_ 20 \_\_\_\_\_

BRIAN PACHECO DISTRICT 1  
STEVE BRANDAU DISTRICT 2  
SAL QUINTERO DISTRICT 3  
BUDDY MENDES DISTRICT 4  
NATHAN MAGSIG CHAIRMAN DISTRICT 5

Steve White  
Digitally signed by Steve White  
Date: 2024.10.15 18:33:33 -0700

APPROVED STEVEN E. WHITE, DIRECTOR  
DEPARTMENT OF PUBLIC WORKS AND PLANNING

PROJECT  
**ROOF REPLACEMENT & FACADE REPAIRS**

5555 E Olive Avenue, Fresno, CA 93727

CLIENT

ARCHITECT

ROBINA WRIGHT  
Architects & Associates, Inc.  
M.S. ARCHITECTURE, CERTIFIED ACCESS SPECIALIST  
LIC # 93283

488 EAST OLIVE AVENUE  
FRESNO, CA 93726  
TEL # 559-307-0222

robina@robinawrightarchitect.com  
robina@robinawright.com

SEAL & SIGNATURE

### PROJECT INFORMATION

- OWNER INFORMATION**  
COUNTY OF FRESNO  
CONTACT PERSON: LUCAS REYES  
INTERNAL SERVICES DEPARTMENT (FACILITIES SERVICES)  
4990 E. KINGS CANYON RD., FRESNO, CA 93702  
CELL: (559) 417-2314
- PROJECT ADDRESS**  
5555 E. OLIVE AVE.,  
FRESNO, CA 93727
- EXISTING SITE DATA**
  - JURISDICTIONAL AGENCY= FRESNO COUNTY
  - A.P. #= 452223-0287
  - CURRENT ZONE= IL (INDUSTRIAL LIGHT)
  - EXISTING LAND USE= OFFICE FACILITY
  - PLANNED LAND USE= NO CHANGE IN LAND USE
  - GROSS LOT AREA= 9.70 ACRE
- EXISTING BUILDING DATA**

**EXISTING USE:**  
OFFICE GROUP "B" OCCUPANCY

**TYPE OF CONSTRUCTION**  
A. FIRE SPRINKLERED  
B. NUMBER OF STORIES -1

**NO CHANGE IN USE AND TYPE PROPOSED.**

- BUILDING FACADE REPAIRS - REPAIR, REPLACEMENT OF WATER, DAMAGED SOFFIT, BRICK VENEERS REPAIR
  - RE-ROOFING AND STRUCTURAL FRAMING ANALYSIS
- APPROXIMATE AREA OR REPAIR AND RE-ROOF: 115,000 SQ. FT.

**ALL FUTURE ROOF MOUNTED HVAC UNITS ARE NOT PART OF THIS SUBMITTAL AND WILL BE UNDER SEPARATE PERMIT.**

UPDATE  
SEPTEMBER 18, 2024

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### DRAWING SYMBOLS

**BUILDING SECTION / EXTERIOR ELEVATION**

SECTION IDENTIFICATION

SHEET NUMBER

**WALL SECTION**

SECTION IDENTIFICATION

SHEET NUMBER

**DETAIL REFERENCE**

DETAIL NUMBER

SHEET NUMBER

**GRID BUBBLE - PROPOSED / EXISTING**

GRID NUMBER

GRID LINE

**ELEVATION DATUM**

LEVEL NAME

LEVEL ELEVATION

**NORTH ARROW**

TRUE NORTH

PROJECT NORTH


**GRID REFERENCE**

View Title  
DRAWING SCALE

DRAWING LOCATION LABEL:  
LABEL IS DETERMINED BY BOTTOM NUMBER & RIGHT LETTER OF THE GRID WHERE THE DETAIL IS DRAWN.

### GENERAL NOTES

- SCOPE OF WORK SHALL BE CONSTRUCTED ACCORDING TO THESE WORKING DRAWINGS AS AGREED UPON BETWEEN OWNER AND CONTRACTOR. THE WORD "CONTRACTOR" REFERS TO THE GENERAL CONTRACTOR. "SUBCONTRACTOR" REFERS TO ONE HAVING DIRECT CONTACT WITH THE CONTRACTOR.
- CONTRACTOR'S RESPONSIBILITIES  
A. CONTRACTOR AND SUBCONTRACTORS SHALL VISIT THE JOB SITE BEFORE THEIR BID IS SUBMITTED TO FAMILIARIZE THEMSELVES WITH EXISTING CONDITIONS.  
B. THE GENERAL CONTRACTOR SHALL READ, EXAMINE AND BE THOROUGHLY FAMILIAR WITH THESE DRAWINGS AND WITH THE EXISTING SITE CONDITIONS PRIOR TO THE START OF WORK. IN THE EVENT THERE ARE DISCREPANCIES OR OMISSIONS WITHIN THE DRAWINGS AND/OR SPECIFICATIONS, THE GENERAL CONTRACTOR SHALL NOTIFY THE ARCHITECT IMMEDIATELY.  
C. THE GENERAL CONTRACTOR IS RESPONSIBLE FOR OBTAINING ALL PERMITS REQUIRED FOR THE SUCCESSFUL COMPLETION OF THE PROJECT.  
D. EXPOSED UNFINISHED SURFACES CREATED BY REMOVAL OF EXISTING MATERIALS, AND SURFACES DAMAGED OR DISTURBED BY REMODELING WORK, SHALL BE REPAIRED/PATCHED WITH NEW MATERIALS AND FINISHED TO MATCH EXISTING WORK AS MUCH AS IS REQUIRED TO PROVIDE A SIMILAR EVEN APPEARANCE.  
E. NO DRAWINGS, DETAILS, NOTES ETC., SHALL BE INTERPRETED TO ALLOW FOR A VIOLATION OF THE LOCAL BUILDING CODE, STATE BUILDING CODE AND OTHER APPLICABLE CODES AND GOOD CONSTRUCTION PRACTICES.  
F. THE GENERAL CONTRACTOR SHALL REVIEW ALL GRADE ELEVATIONS PRIOR TO CONSTRUCTION.  
G. CONTRACTORS SHALL VERIFY ALL DIMENSIONS, CONSTRUCTION METHODS, MATERIALS, SIZE OF MEMBERS, ETC., PRIOR TO ON-SITE DELIVERY.  
H. JOB SHALL BE COMPLETED WITH AS MUCH SPEED AS POSSIBLE WHEN WORK BEGINS.  
I. OWNERS SHALL NOT MAKE ANY PAYMENTS TO THE GENERAL CONTRACTOR OR ANY SUBCONTRACTOR WITHOUT RECEIVING LIEN RELEASES FROM ALL PEOPLES WHO HAVE PROVIDED LABOR OR MATERIAL.  
J. PERMITS THE CONTRACTOR AND SUBCONTRACTOR SHALL OBTAIN AND PAY ALL PERMITS, LICENSES AND FEES REQUIRED BY CITY, COUNTY AND STATE LAWS, EXCEPT THE BUILDING, ELECTRICAL, MECHANICAL, AND PLUMBING PLAN FEES AND PERMIT FEES, WHICH WILL BE PAID FOR BY THE OWNER. ALL LAWS, ORDINANCES AND REGULATIONS SHALL BE COMPLIED WITH AND ALL NECESSARY EXPENSES FOR COMPLIANCE SHALL BE INCLUDED IN THE CONTRACT.  
K. THE CONTRACTOR SHALL OBTAIN ALL REQUIRED INSPECTIONS FOR HIS WORK AND GIVE THE OWNER TIMELY NOTICE OF HIS INTENT TO HAVE INSPECTION.  
L. THE GENERAL CONTRACTOR SHALL COORDINATE AND VERIFY WITH THE PLUMBING, MECHANICAL AND ELECTRICAL CONTRACTORS, THE SIZE AND LOCATION OF ALL PIPING, DUCTWORK, TRENCHES, SLEEVES, SPECIAL BOLTING FOR EQUIPMENT CONDUITS, ETC., THE DESIGN, ADEQUACY AND SAFETY OF ERECTION, BRACING, SHORING, TEMPORARY SUPPORTS, ETC., IS THE SOLE RESPONSIBILITY OF THE CONTRACTOR, AND HAS NOT BEEN CONSIDERED BY THE STRUCTURAL ENGINEER AND ARCHITECT.  
M. THE CONTRACTOR SHALL PROVIDE ALL RISK INSURANCE. REFER TO PROJECT MANUAL FOR MINIMUM LIABILITY AND PROJECT DAMAGE COVERAGE.  
N. THE GENERAL CONTRACTOR SHALL PROVIDE AND MAINTAIN TEMPORARY SANITARY FACILITY ENCLOSURES. LOCATE AS DIRECTED BY OWNER. NEW FACILITIES SHALL NOT BE USED DURING CONSTRUCTION.  
O. THE GENERAL CONTRACTOR IS RESPONSIBLE FOR OBTAINING ALL PERMITS REQUIRED FOR THE SUCCESSFUL COMPLETION OF THE PROJECT.  
P. THE GENERAL CONTRACTOR AND ALL SUBCONTRACTORS SHALL COMPLY WITH ALL APPLICABLE LAWS AND CODE REGULATIONS. THESE CODES INCLUDE BUT NOT LIMITED TO THE FOLLOWING:  
**2022 CALIFORNIA BUILDING CODE (CBC)**  
**2022 CALIFORNIA FIRE CODE**  
**2022 CALIFORNIA MECHANICAL CODE (CMC)**  
**2022 CALIFORNIA ELECTRICAL CODE (CEC)**  
**2022 CALIFORNIA FIRE CODE**  
**2022 CALIFORNIA RESIDENTIAL CODE**  
**2022 CALIFORNIA ENERGY CODE**  
**2022 CALIFORNIA GREEN BUILDING STANDARDS CODE (CAL GREEN)**  
**COUNTY OF FRESNO MUNICIPAL ORDINANCE**
- ERRORS AND OMISSION: IF ANY ERRORS OR OMISSIONS APPEAR IN THESE DRAWINGS, OR OTHER CONTRACT DOCUMENTS, THE GENERAL CONTRACTOR AND SUBCONTRACTORS AFFECTED SHALL NOTIFY THE ARCHITECT IN WRITING OF SUCH ERROR OR OMISSION. IN THE EVENT OF FAILING TO DO SUCH WRITTEN NOTICE BEFORE CONSTRUCTION AND/OR FABRICATION OF THE WORK, HE WILL BE HELD RESPONSIBLE FOR THE RESULT OF THE ANY SUCH ERRORS OR OMISSIONS AND THE COST FOR RECTIFYING THE SAME.
- GUARANTEES: CONTRACTOR SHALL GUARANTEE THE WORK IN GENERAL FOR ONE YEAR AGAINST DEFECTS IN MATERIALS AND WORKMANSHIP. THE GENERAL CONTRACTOR SHALL BE RESPONSIBLE FOR LEAVING THE BUILDING FREE FROM DEFECTS OF MATERIALS AND POOR WORKMANSHIP FROM DATE OF COMPLETION. THE CONTRACTOR SHALL FURNISH A WRITTEN GUARANTEE STATING THAT ALL WORK EXECUTED BY HIM WILL BE FREE FROM DEFECTS OF THE MATERIALS AND WORKMANSHIP FOR PERIOD OF ONE YEAR (UNLESS OTHERWISE SPECIFIED) FROM DATE OF ACCEPTANCE OF HIS WORK. THAT HE WILL REPAIR AND REPLACE ALL SUCH DEFECTIVE WORK AND ALL OTHER WORK DAMAGE WITHOUT COST TO THE OWNER.
- DIMENSIONS: FIGURED DIMENSIONS SHALL BE FOLLOWED IN PREFERENCE TO SMALL SCALE DRAWINGS. THE CONTRACTOR SHALL VERIFY ALL DIMENSIONS IN THE FIELD BEFORE ANY WORK IS CONSTRUCTED AND/OR FABRICATED. THE SPECIFICATION AND/OR SCHEDULES ON THE DRAWINGS SHALL HAVE WRITTEN NOTES AND OR BE FOLLOWED IN PREFERENCE TO INFORMATION FURNISHED IN THE FORM OF LINES ON DRAWINGS. DETAILED CLARIFICATION DRAWINGS FURNISHED DURING CONSTRUCTION OR APPROVED BY THE ARCHITECT ARE TO BE CONSIDERED EXPLANATORY AND NOT AS MODIFICATIONS OF THESE PLANS AS SHALL BE CALLED CLARIFICATION DRAWINGS. ALL NOTES, FIGURES AND DETAIL DRAWINGS SHALL BE FOLLOWED AND EXECUTED AS PART OF THESE NOTES. ALL WRITTEN DIMENSIONS SHALL TAKE PRECEDENCE OVER SCALED DIMENSIONS. DIMENSION LINES ARE TO FACE OF STUD UNLESS NOTED OTHERWISE (U.O.)

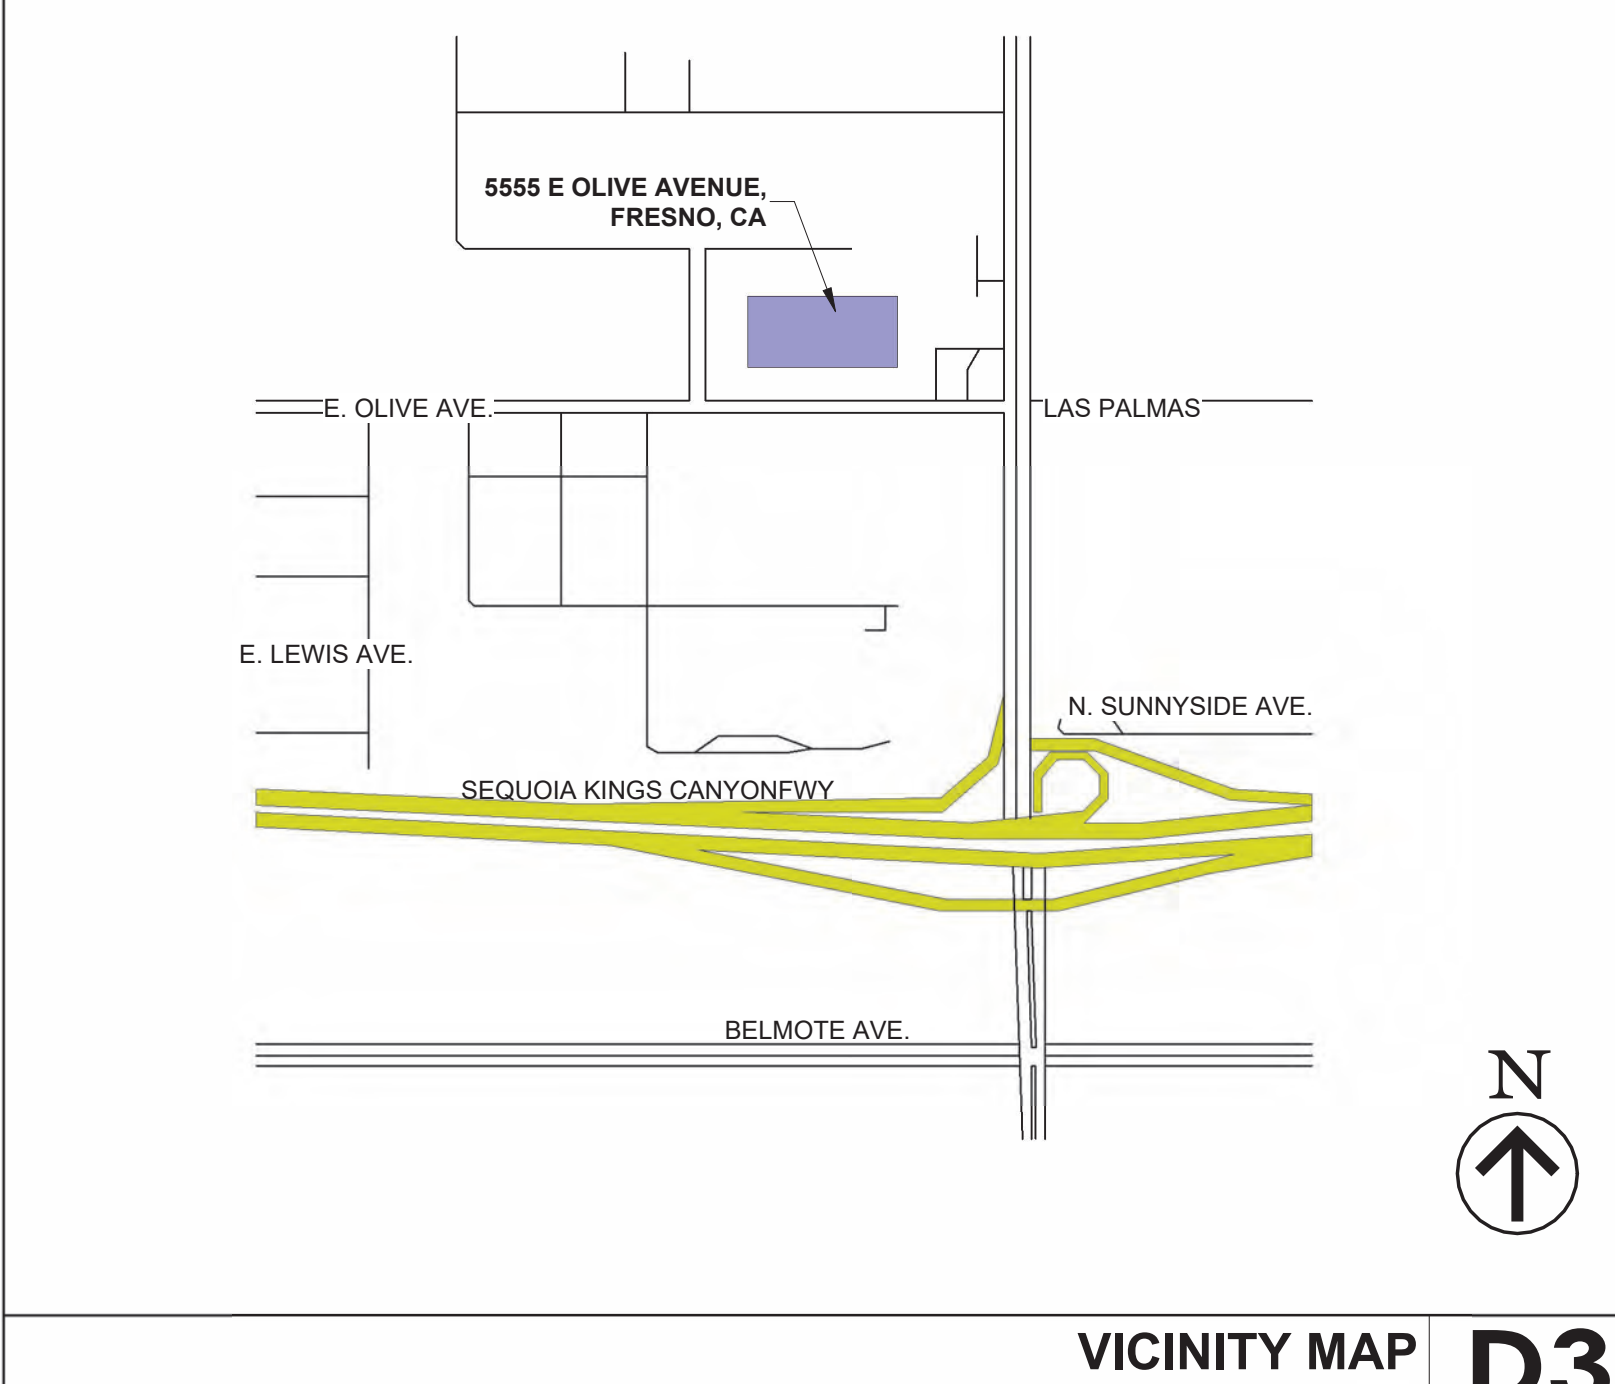

### GENERAL DEMOLITION NOTES:

- THE CONTRACTOR IS RESPONSIBLE FOR DETERMINING THE EXTENT OF DEMOLITION REQUIRED FOR THE EXECUTION OF THE WORK. THE CONTRACTOR SHALL NOTIFY THE ARCHITECT OF ANY CONDITION DISCOVERED DURING DEMOLITION WHICH AFFECTS THE STRUCTURAL INTEGRITY OF THE BUILDING AND MATERIALLY IMPACTS THE ABILITY OF THE CONTRACTOR TO EXECUTE THE WORK.
- THESE NOTES AND SPECIFICATIONS SHALL APPLY UNLESS SPECIFICALLY NOTED OTHERWISE. DETAILS OF CONSTRUCTION NOT SPECIFICALLY SHOWN SHALL BE BUILT PER DETAILS SHOWN FOR SIMILAR MATERIALS AND CONDITIONS.
- VERIFY ALL EXISTING CONDITIONS, MEASUREMENTS AND CIRCUMSTANCES APPROPRIATE TO THE SITE BEFORE STARTING WORK. STUDY THE DRAWINGS AND VERIFY WITH EXISTING CONDITION IN DETAIL PRIOR TO COMMENCING AND DEMOLITION WORK. REPORT DISCREPANCIES OR CONDITIONS WHICH MIGHT DISRUPT BUILDING FUNCTIONS TO ARCHITECT BEFORE DISTURBING EXISTING INSTALLATION.
- THE CONTRACTOR SHALL PROVIDE REQUIRED PROTECTION INCLUDING BUT NOT NECESSARILY LIMITED TO SHORING, BRACING, AND SUPPORT TO MAINTAIN STRUCTURAL INTEGRITY OF THE WORK.
- UNLESS OTHERWISE NOTED ON THE DRAWINGS OR SPECIFICATIONS DO NOT CUT OR ALTER STRUCTURAL MEMBERS WITHOUT WRITTEN AUTHORIZATION FROM THE ARCHITECT.
- WHERE DEMOLITION, REMOVAL OR REWORK OCCURS, TAKE ALL NECESSARY PRECAUTIONS TO PROTECT EXISTING WORK REMAINING IN PLACE FROM DAMAGE. FINISHED WORK DAMAGED BY OPERATIONS UNDER THIS CONTRACT SHALL BE REPAIRED OR REPLACED TO THE SATISFACTION OF THE ARCHITECT AT NO INCREASE IN CONTRACT PRICE.
- DRILL, CUT, ALTER, REMOVE, OR TEMPORARILY REMOVE AND REPLACE EXISTING CONSTRUCTION AS NECESSARY FOR PERFORMANCE OF WORK UNDER THIS CONTRACT.
- CUT FINISH SURFACES SUCH AS CONCRETE, PLASTER OR METALS BY METHODS TO TERMINATE SURFACES IN A STRAIGHT LINE AT A NATURAL POINT OF DIVISION.
- WHERE NEW WORK JOINS EXISTING CONSTRUCTION, ENSURE THAT JOINING ARE WEATHERTIGHT, SOUND AND EVEN IN APPEARANCE.
- EXPOSED UNFINISHED SURFACES CREATED BY REMOVAL OF EXISTING MATERIALS, AND SURFACES DAMAGED OR DISTURBED BY REMODELING WORK, SHALL BE REPAIRED/PATCHED WITH NEW MATERIALS AND FINISHED TO MATCH EXISTING WORK AS MUCH AS IS REQUIRED TO PROVIDE A SIMILAR EVEN APPEARANCE.
- IF REMOVAL OF EXISTING WORK EXPOSED DISCOLORED OR UNFINISHED SURFACES OR WORK OUT OF ALIGNMENT, REFINISH SUCH SURFACES OR REPLACE THE MATERIAL AS NECESSARY TO MAKE CONTIGUOUS WORK UNIFORM.
- FIXTURES AND OUTLETS TO BE REMOVED SHALL HAVE THEIR UTILITY LINES CAPPED WITHIN WALLS OR FLOORS. UTILITY LINES ENCOUNTERED IN THE WORK SHALL BE CAPPED, EXTENDED OR REWORKED AS NECESSARY FOR COMPLETION OR REMODELING.
- ALL EXISTING ELECTRICAL WIRING, RECEPTACLES NOT TO BE USED SHALL BE REMOVED.
- WHERE NEW STUD FRAMING IS USED TO INFLU OR ALIGN W/ (E) WALL, PURR AS REQUIRED TO MATCH (E) STUD WIDTH. ALL MATERIALS FROM DEMOLITION AND ALTERATION WHICH ARE NOT TO BE REUSED SHALL BE PROMPTLY REMOVED FROM THE SITE.
- ALL EXISTING ELECTRICAL AND PLUMBING DRAIN LINES, SUPPLY LINES, VENTS, FIXTURES NOT TO BE USED SHALL BE REMOVED OR CAPPED.
- REPLACE ANY MEMBERS DAMAGED DURING DEMOLITION OR DUE TO INSECT, WATER ETC. REPLACED MEMBERS SHALL MATCH (E) IN SIZE, GRADE TO BE DR#2 OR BETTER.
- PLEASE NOTE THAT ALL SPECIFIED MATERIALS ARE SUBJECT TO REWORK.
- COMMENCING DEMOLITION INDICATES THAT THE CONTRACTOR ACCEPTS EXISTING CONDITIONS.
- FIELD VERIFY NON-BEARING AND STRUCTURAL CONDITION PRIOR TO START OF WORK.
- STORE ITEMS TO BE RE-USED IN A PROTECTED LOCATION UNTIL REINSTALLATION.

**DRAWING LIST**

A-100	COVER PAGE
A-202.0	ROOF DEMOLITION PLAN
A-202.1	PROPOSED ROOF PLAN
A-203	REFLECTED CEILING DEMOLITION PLAN
A-203.1	PROPOSED REFLECTED CEILING PLAN
A-301	ELEVATIONS
A-401	WALL SECTIONS
A-402	WALL SECTIONS
A-801	ARCHITECTURAL DETAILS
A-802	ARCHITECTURAL DETAILS
A-803	ARCHITECTURAL DETAILS
S-101	GENERAL NOTES AND TYPICAL DETAILS
S-202	ROOF FRAMING PLAN
M-100	SITE PLAN AND NOTES
M-101	MECHANICAL SCHEDULES
M-102	MECHANICAL SCHEDULES
M-103	MECHANICAL SCHEDULES
M-104	MECHANICAL SCHEDULES
M-105	MECHANICAL DETAILS
M-300	MECHANICAL ROOF PLAN - OVERALL
M-301	MECHANICAL ROOF PLAN - AREA A
M-302	MECHANICAL ROOF PLAN - AREA B
M-303	MECHANICAL ROOF PLAN - AREA C
M-304	MECHANICAL ROOF PLAN - AREA D

**8.5 X 11 ATTACHMENTS:**

- EXHIBIT 01 - SPECIFICATIONS
- EXHIBIT 02 - STRUCTURAL ANALYSIS
- EXHIBIT 03 - HVAC SUBMITTAL DATA

**APPROVED FOR PERMIT**

This plan is in general conformance with Title 15 of the Fresno County Ordinance Code. This approval does not constitute permission to violate any applicable county ordinance or state law.

By: **jousart** 09/25/24  
DATE  
COUNTY OF FRESNO

### COVER PAGE

SCALE As indicated

**PO #491344**

**A-100**

ISSUE DATE MAY 23, 2024 JOB NUMBER 2024\_10


DRAWN BY Author CHECKED BY Checker

### DRAWING SYMBOLS A11

### GENERAL NOTES A6

### GENERAL DEMOLITION NOTES A3

9/18/2024 6:21:38 PM  
30" x 42"

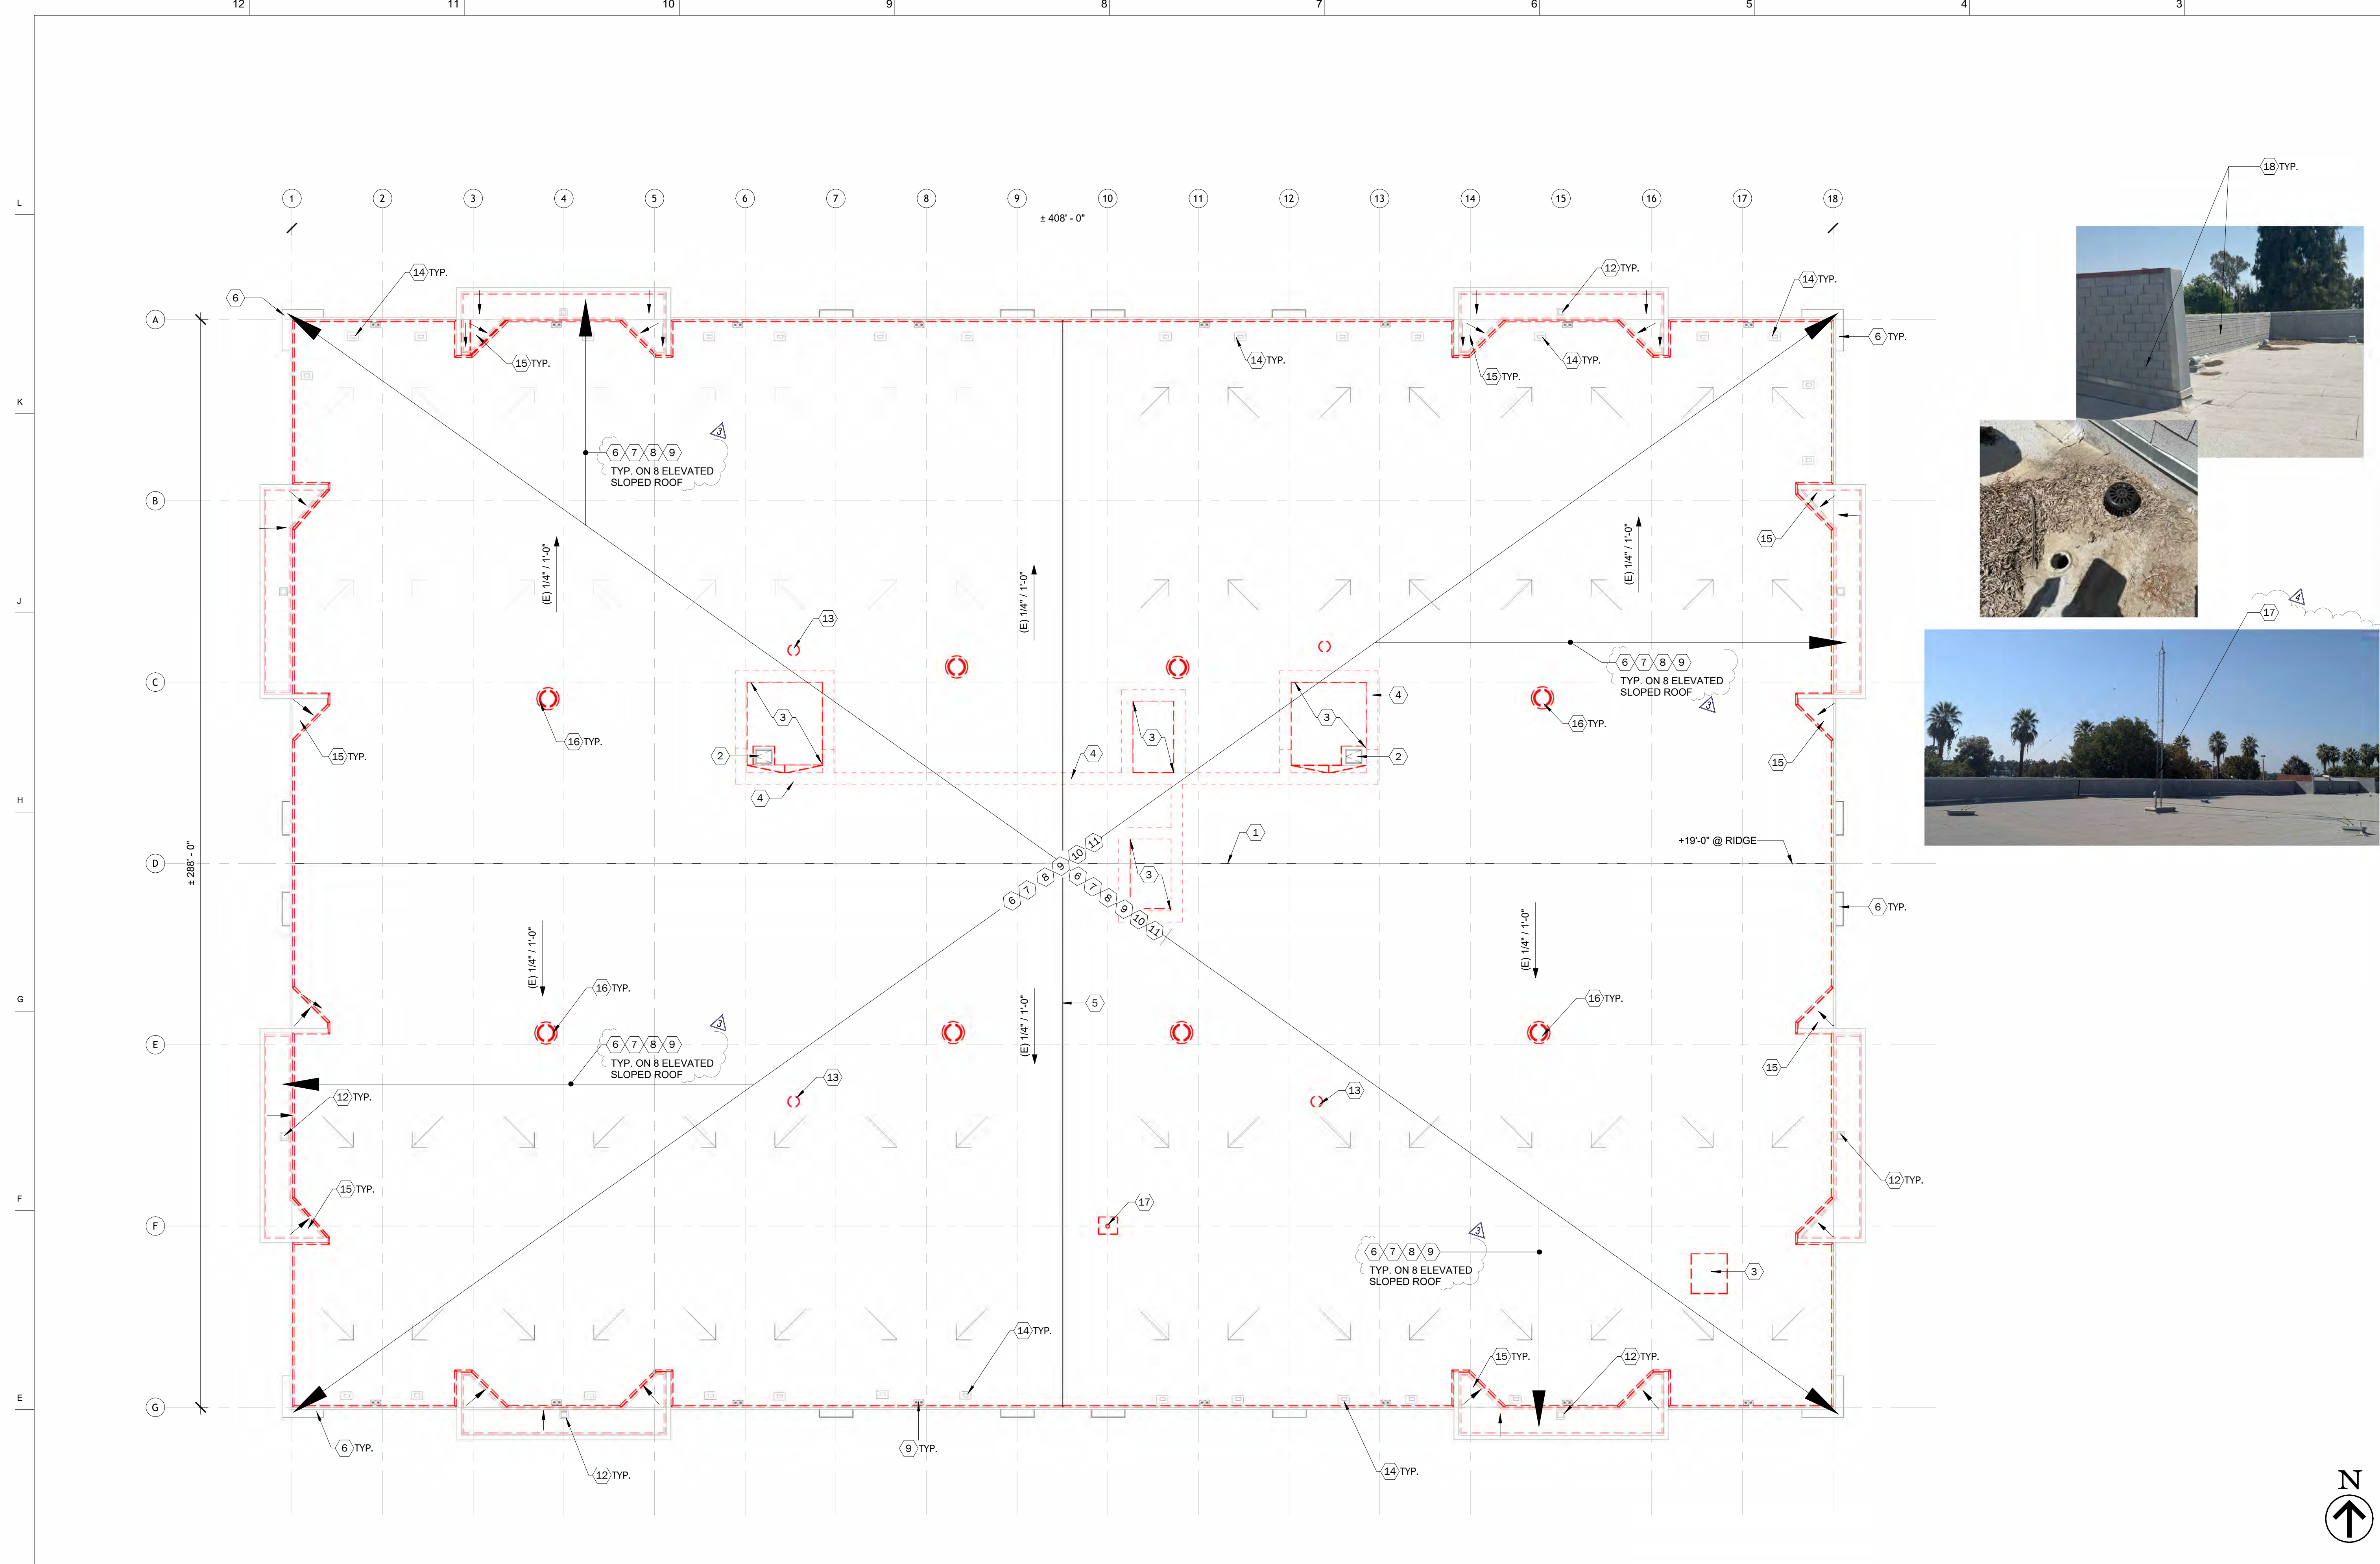

- DEMOLITION PLAN KEYNOTES:**
- EXISTING RIDGE LINE
  - EXISTING ROOF HATCH
  - REMOVE EXISTING EQUIPMENT PLATFORM. PRESERVE (E) ROOF HATCH. PRESERVE EXISTING HATCH AND RETAIN PORTION OF EQUIPMENT PLATFORM AROUND PERIMETER OF EXISTING ROOF HATCH. PATCH, REPAIR AND RESEAL AS REQUIRED TO PRESERVE HATCH. REFER TO A2/A-202.1 FOR ADDITIONAL INFORMATION.
  - REMOVE EXISTING ROOF WALKWAY PADS. TYPICAL FOR ADDITIONAL INFORMATION.
  - REPLACE EXISTING EXPANSION JOINT. REFER TO A2/A-202.1 FOR ADDITIONAL INFORMATION.
  - REMOVE EXISTING PARAPET CAP, FLASHING AND COUNTER FLASHING ASSEMBLIES. CLEAN AND PREPARE SURFACE FOR INSTALLATION OF NEW PARAPET CAP, FLASHING AND COUNTER FLASHING. REFER TO A2/A-202.1 FOR ADDITIONAL INFORMATION.
  - REMOVE EXISTING ROOFING INSULATION. CLEAN AND PREPARE FOR INSTALLATION OF NEW ROOFING INSULATIONS.
  - REMOVE EXISTING SLOPED PLYWOOD SHEATHING. PROTECT FROM DAMAGE DURING THE WORK. CLEAN ROOF AND REMOVE ANY DEBRIS, NAILS AND OTHER APPURTENANCES PRIOR TO INSTALLING NEW ROOF.
  - REMOVE AND SALVAGE FOR REINSTALLATION EXISTING ROOF DRAINS, CLEAN AND MAINTAIN EXISTING ROOF DRAIN AND PIPING. EXTEND TO SURFACE OF NEW MEMBRANE ROOF. REFER TO A2/A-202.1 FOR ADDITIONAL INFORMATION.
  - REMOVE EXISTING CURBS, CRICKETS AND CURB FLASHING AROUND EXISTING EQUIPMENT PLATFORM.
  - CLEAN EXISTING OVER-FLOW DRAINS. REMOVE DIRT AND GRIMES.
  - EXISTING ROOF VENT.
  - EXISTING VENT THRU ROOF. FIELD VERIFY APPLICATION. REMOVE EXISTING ROOF EXHAUST VENTS SERVING EXISTING GAS FIRED WATER HEATER. FIELD VERIFY EXACT LOCATIONS.
  - EXISTING SOFFIT VENTS. TYPICAL ON SOFFIT CONDITIONS.
  - EXISTING BUILT-UP CRICKET. REMOVE / REPAIR AS REQUIRED TO DIRECT WATER TO ROOF DRAIN. TYPICAL ON ALL.
  - REMOVE EXISTING DOWNBLAST EXHAUST FANS.
  - REMOVE EXISTING ROOFTOP ANTENNA TOWER, SUPPORT CABLES, AND CONNECTION CURBS; SALVAGE AND RETURN TO OWNER.
  - REMOVE EXISTING COMPOSITION TILE FLASHING ALONG SIDEWALL PERIMETER. CLEAN AND PREPARE FOR INSTALLATION OF NEW ROOFING MEMBRANE.


- GENERAL NOTES:**
- RAISE AND EXTEND EXISTING TO REMAIN SEWER VENTS, VENT STACKS, FLUES, GAS AND OTHER MECHANICAL, ELECTRICAL AND PLUMBING SYSTEMS TO A MINIMUM OF 8" ABOVE THE SURFACE OF NEW ROOF. FIELD VERIFY LOCATIONS. REPLACE FLASHING FOR AFFECTED CURBS.
  - REMOVE EXISTING T&P (TEMPERATURE & PRESSURE) RELIEF PIPES SERVING WATER HEATERS AND TERMINATING THROUGH THE ROOF. FIELD VERIFY EXACT LOCATION.
  - IT IS THE CONTRACTOR'S RESPONSIBILITY TO NOTIFY THE OWNER, OWNERS REPRESENTATIVE & ARCHITECT OF ANY EXISTING DEFICIENCIES SUCH AS MOLD, DRY ROT ETC. STRUCTURAL DEFICIENCIES IN EXISTING STRUCTURE REVEALED DURING THE DEMOLITION PHASE THAT WILL NEED TO BE ADDRESSED BY THE STRUCTURAL ENGINEER AND/OR JURISDICTIONAL AGENCY. ANY WORK CARRIED OUT PRIOR TO OR WITHOUT APPROVAL OF ENGINEER OR JURISDICTIONAL AGENCY, WILL BE AT RISK. THE OWNER, ITS REPRESENTATIVE AND THE ARCHITECTS (AND ITS ENGINEER) WILL NOT BE RESPONSIBLE FOR ANY COSTS INCURRED FOR NON-COMPLIANT WORK CARRIED OUT WITHOUT THE EXPRESS APPROVAL OF THE ENGINEER OR JURISDICTIONAL AGENCY.
  - CONTRACTOR IS REQUIRED TO VERIFY ALL DIMENSIONS, EXISTING EQUIPMENT AND CONDITIONS ON THE ROOF.
  - DASHED LINE DENOTES AREAS OF DEMOLITION. KEYNOTED ITEMS ARE FOR ADDITIONAL CLARIFICATION.

**APPROVED**  
Sep 25 2024  
COUNTY OF FRESNO  
DEVELOPMENT SERVICES

PROJECT  
**ROOF REPLACEMENT & FACADE REPAIRS**  
5555 E Olive Avenue, Fresno, CA 93727



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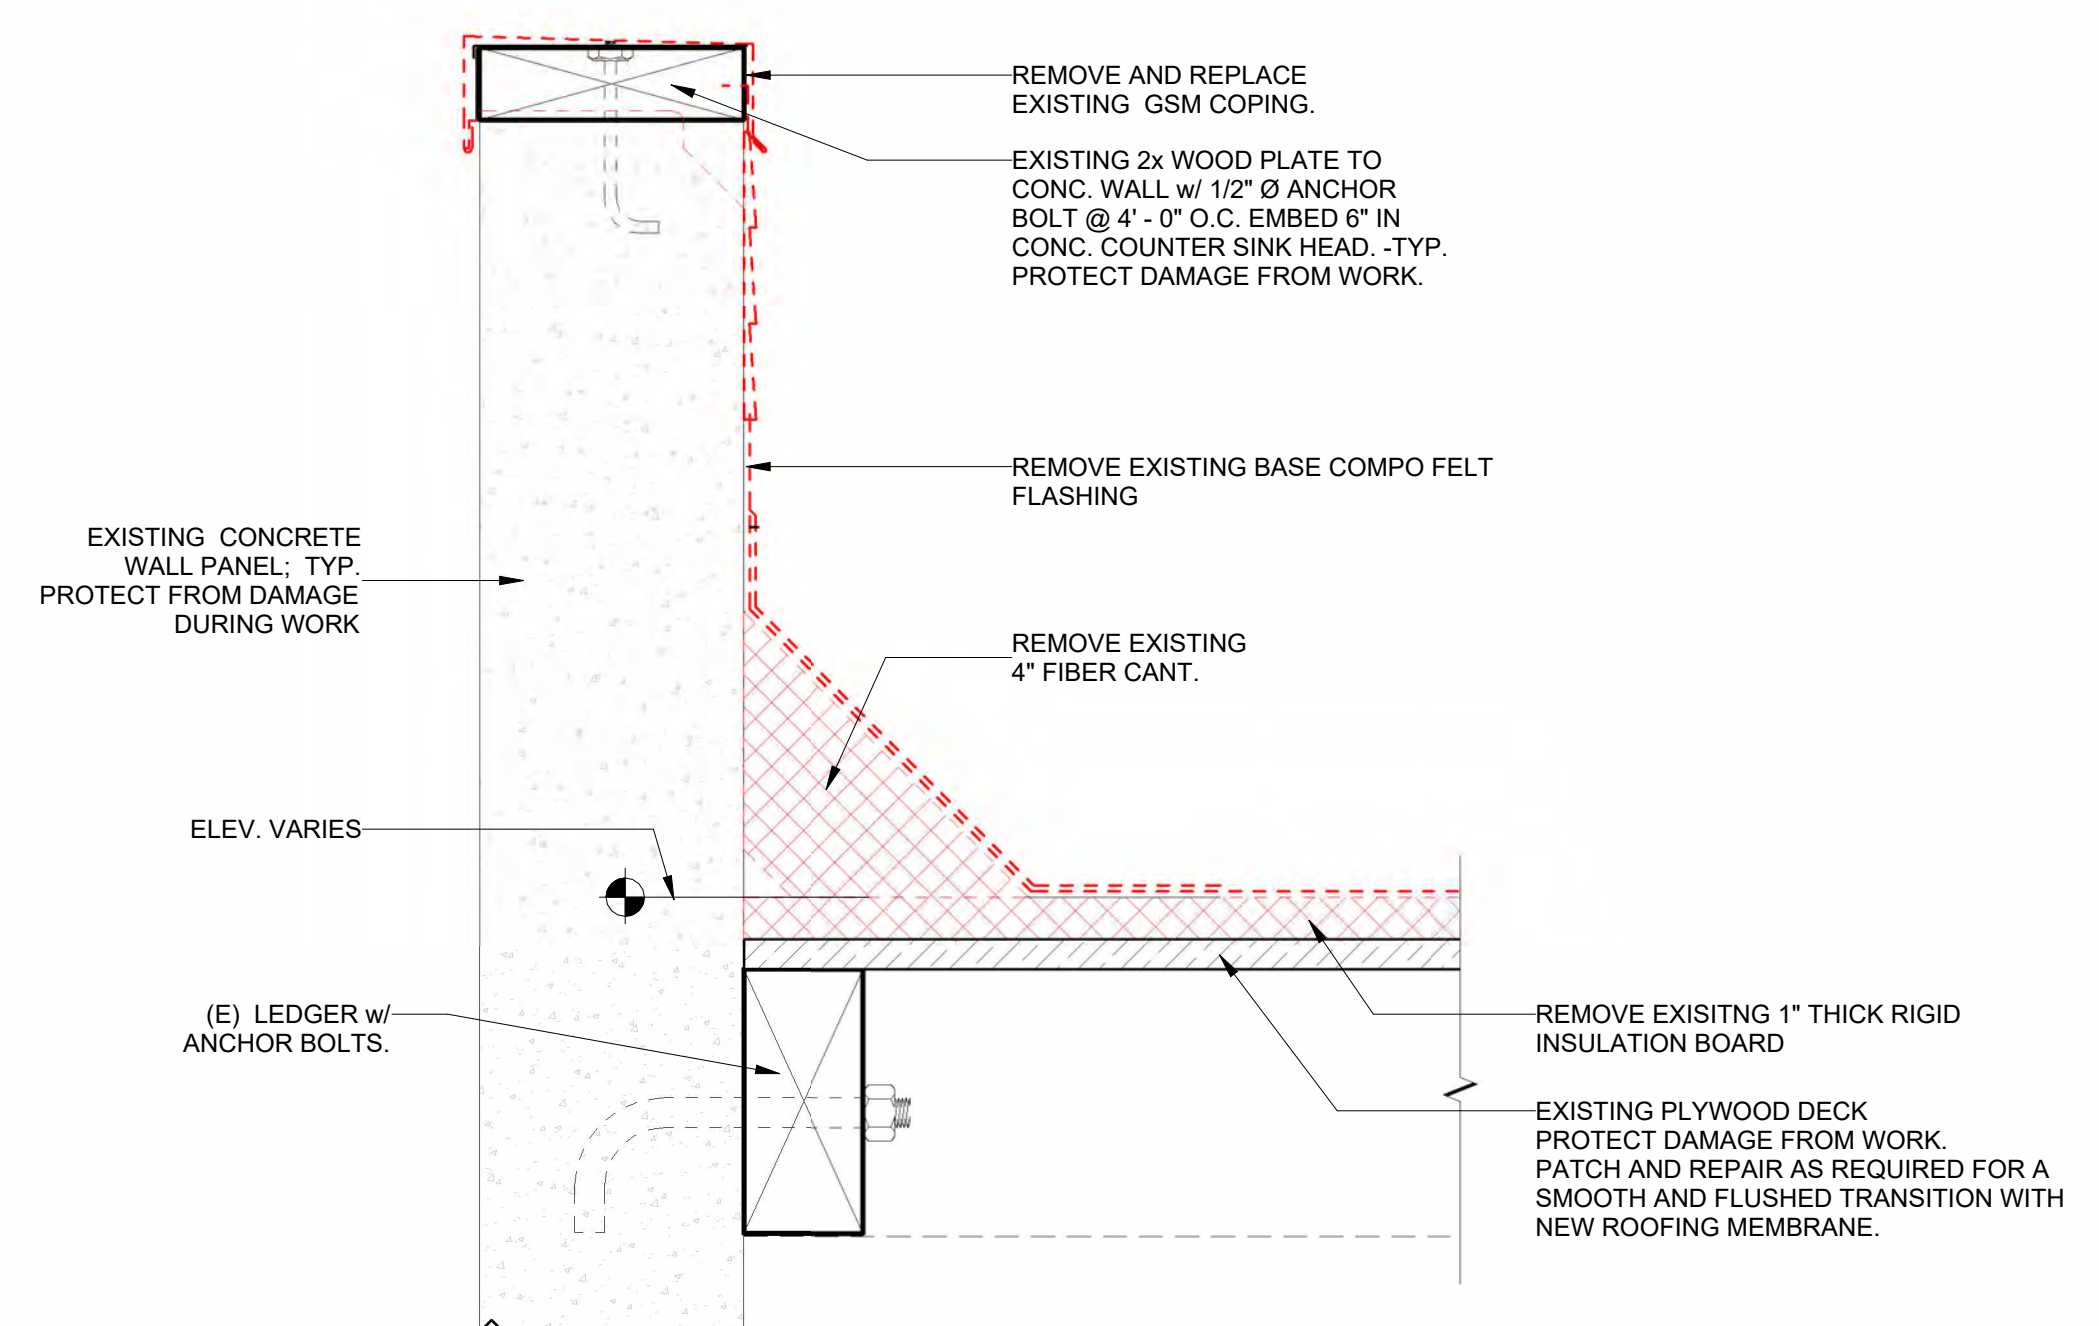


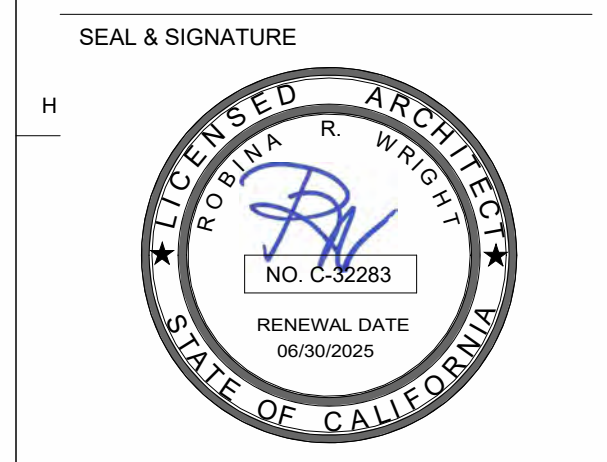CONSULTANT  
**APPROVED**  
Sep 25 2024  
COUNTY OF FRESNO  
DEVELOPMENT SERVICES  
UPDATE  
OCTOBER 21, 2024


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2	OWNER REVISIONS	2024 08 21
3	01 ADDENDUM	2024 10 21
4	OWNER REVISIONS	2024 10 21

**ROOF DEMOLITION PLAN D2**  
1" = 20'-0"



**TYPICAL ROOF DEMO DETAIL A2**  
3" = 1'-0"

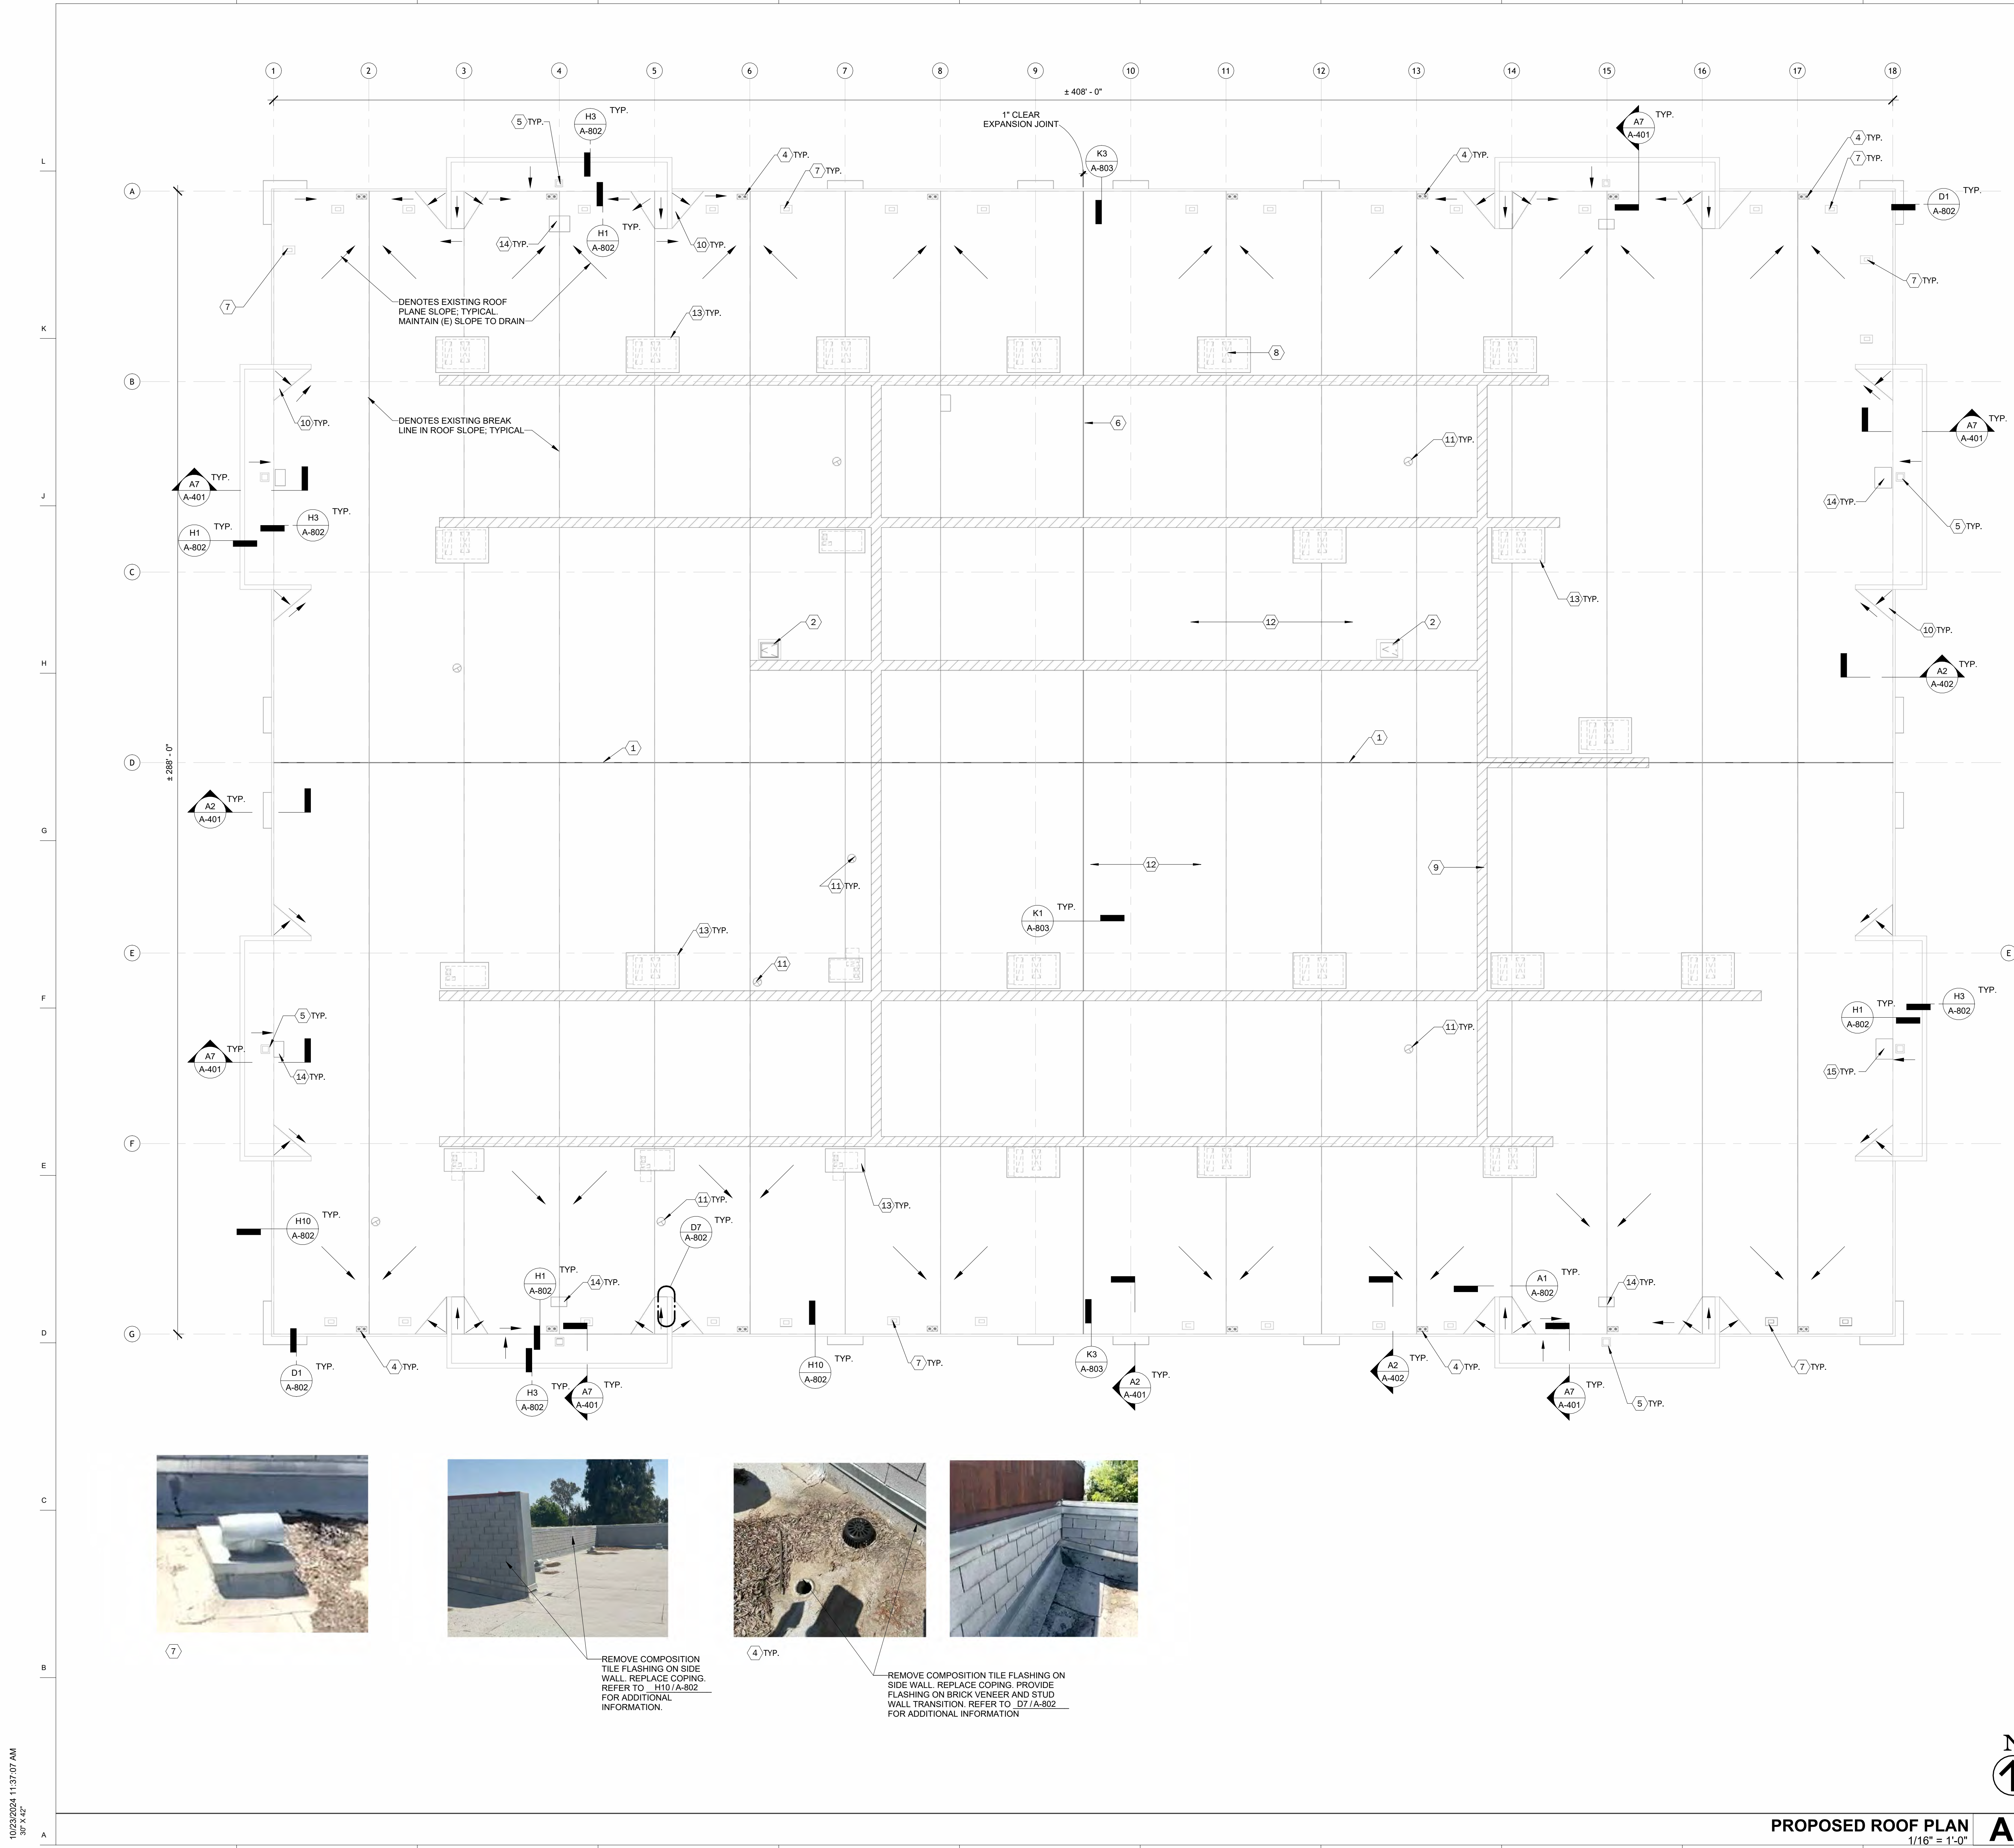

- ### ROOF PLAN KEYNOTES:
- EXISTING RIDGE LINE
  - EXISTING ROOF HATCH. RETAIN PORTION OF MECHANICAL PLATFORM FOR ROOF HATCH ACCESS. SEE D3/A-802
  - EXISTING TOWER AND CABLE SUPPORT
  - EXISTING ROOF DRAIN AND OVERFLOW. REMOVE AND SALVAGE FOR REINSTALLATION AS REQUIRED FOR NEW ROOFING MEMBRANE INSTALLATION. CLEAN, REMOVE DIRT AND GRIMES AND EXTEND TO SURFACE OF NEW MEMBRANE ROOF. REFER TO A10/A-802 AND D10/A-802 FOR ADDITIONAL INFORMATION.
  - EXISTING ROOF VENT. PROTECT FROM DAMAGE. INSTALL FLASHING PER MANUFACTURER INSTALLATION INSTRUCTIONS. REFER TO A7/A-802 FOR ADDITIONAL INFORMATION.
  - EXPANSION JOINT WITH 1" CLEAR
  - EXISTING SOFFIT VENT. REFER TO A7/A-802 AND A3/A-803 FOR ADDITIONAL INFORMATION.
  - PROPOSED NEW AIR CONDITIONER DIRECT DRIVE PACKAGE ROOF TYPE UNIT. REFER TO MECHANICAL FOR ADDITIONAL INFORMATION.
  - PROPOSED 30" WIDE ROOF WALKWAY PADS. PROVIDE AROUND UNITS CLOSED TO EQUIPMENT AND ACCESS PANELS.
  - EXISTING BUILT-UP CRICKET. REMOVE OR REPAIR AS REQUIRED TO DIRECT WATER TO ROOF DRAIN. TYPICAL ON ALL.
  - PROPOSED BUILT-UP CURB FOR FUTURE ROOF MOUNT EXHAUST FAN. REFER TO REFERENCED MECHANICAL PLAN FOR ADDITIONAL INFORMATION.
  - NEW THERMOPLASTIC KEE ROOFING SYSTEM. SEE SPECIFICATIONS. INSTALL PER MANUFACTURER INSTALLATION INSTRUCTIONS.
  - PROPOSED BUILT-UP CURB FOR FUTURE ROOF MOUNTED HVAC UNIT. REFER TO A3/A-802 AND STRUCTURAL DRAWINGS FOR ADDITIONAL INFORMATION. REFER ALSO TO MECHANICAL PLANS FOR ADDITIONAL INFORMATION.
  - PROPOSED BUILT-UP CURB FOR FUTURE OUTDOOR UNITS. REFER TO A3/A-802 AND FOR ADDITIONAL INFORMATION.

- ### GENERAL NOTES - ROOFING
- VERIFY SIZE, LOCATION AND NUMBER OF ROOF PENETRATIONS INCLUDING VENTS, PIPES, CURBS, ROOF DRAINS, CONDUITS, ETC. PROVIDE NEW FLASHING AND SEAL PENETRATIONS WHETHER OR NOT INDICATED ON THE DRAWINGS.
  - VERIFY AND MAINTAIN ROOF SLOPES AND DRAINAGE PATTERNS. TEST FOR AND CORRECT ANY PONDING CONDITIONS.
  - REPAIR AND REPLACE ROOFING SYSTEM OR STRUCTURE DAMAGED BY IMPROPER STORAGE, CONSTRUCTION ACTIVITIES, OR LACK OF ADEQUATE TEMPORARY PROTECTION.
  - NEW BLOCKING SHALL BE PRESERVATIVE-TREATED WOOD.
  - PAINT EXTERIOR LADDERS, BRACKETS, ETC. UNO CONTRACTOR IS RESPONSIBLE FOR PROTECTION, MODIFICATION AND RE-INSTALLATION OF ALL EXISTING ROOFTOP PIPING, CONDUIT, WIRE AND EQUIPMENT DURING THE ROOF REMOVAL/REPLACEMENT OPERATIONS. THIS INCLUDES, BUT IS NOT LIMITED TO, EXTENSIONS OF EXISTING CONDUIT AND PIPING PENETRATIONS TO ACCOMMODATE NEW ROOFING REQUIREMENTS. REPLACEMENT OR MODIFICATION OF EXISTING SLEEPERS, BLOCKING AND SUPPORTS. PROVIDE NEW CONDUIT, CONDUCTORS, UNISTRUT, ETC. AS NECESSARY TO ACCOMMODATE NEW ROOFING REQUIREMENTS.
  - RESAL AND REINSTALL EQUIPMENTS TO REMAIN.
  - NEW ROOF SYSTEM. INSTALL SINGLE PLY ROOFING SYSTEM, RELATED SHEET METAL FLASHING, WALK PADS ETC. FLASHING INCLUDE BUT NOT LIMITED TO COUNTER FLASHING, CAP FLASHING. NEW ROOF SYSTEM TO SLOPE AS EXISTING.
  - RAISE AND EXTEND SEWER VENTS, VENT STACKS, FLUES, GAS AND OTHER MECHANICAL, ELECTRICAL AND PLUMBING SYSTEMS TO A MINIMUM OF 8" ABOVE THE SURFACE OF NEW ROOF. FIELD VERIFY LOCATIONS. REPLACE FLASHING FOR AFFECTED CURBS.

**APPROVED**  
 Sep 25 2024  
 COUNTY OF FRESNO  
 DEVELOPMENT SERVICES

PROJECT  
**ROOF  
 REPLACEMENT  
 & FACADE  
 REPAIRS**  
 5555 E Olive Avenue, Fresno,  
 CA 93727



CLIENT

ARCHITECT  
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CONSULTANT

UPDATE  
 OCTOBER 21, 2024

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NO.	OWNER REVISIONS	DATE
4	OWNER REVISIONS	2024.10.21

TITLE  
**PROPOSED ROOF  
 PLAN**

SCALE As indicated

**PO #491344**


**A-202.1**

ISSUE DATE MAY 23, 2024 JOB NUMBER 2024\_10

DRAWN BY Author CHECKED BY Checker

10/23/2024 11:37:07 AM  
38"x44"

**PROPOSED ROOF PLAN**  
 1/16" = 1'-0" **A2**

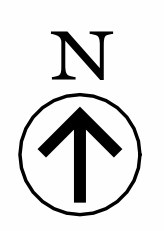











10/23/2024 11:37:25 AM  
30' x 42'

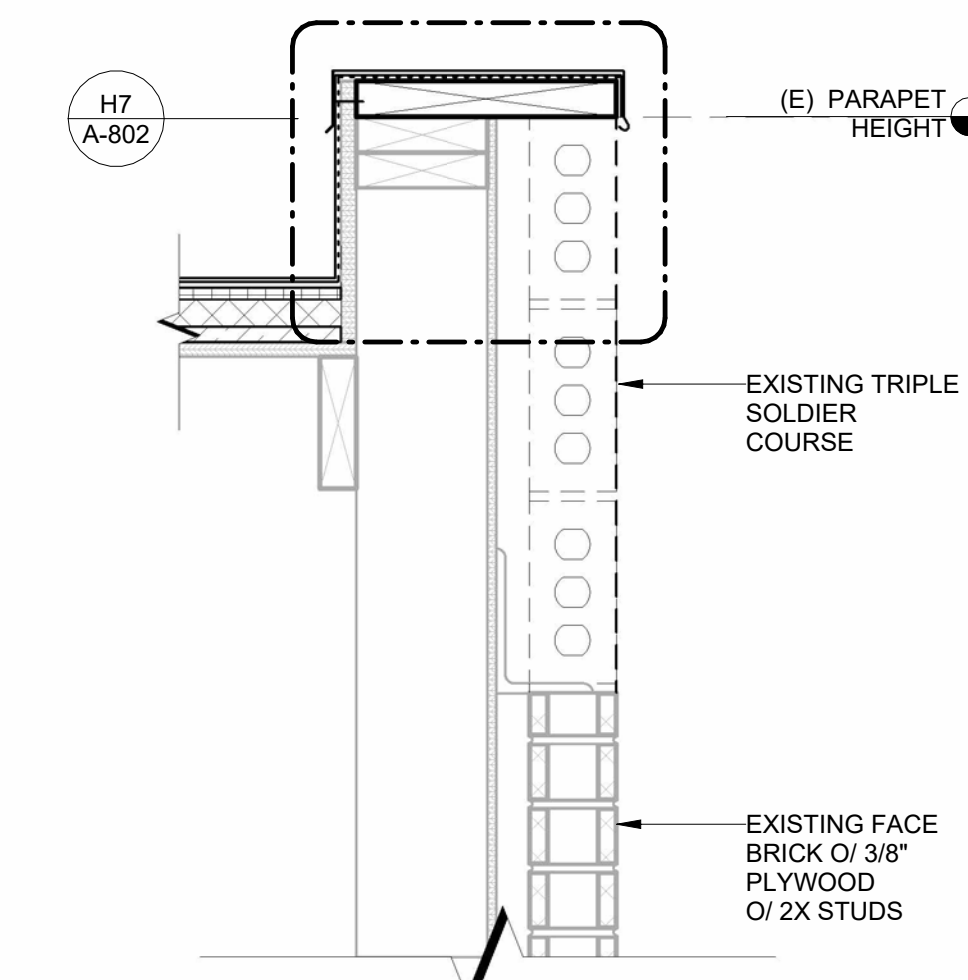

**DETAIL AT EXISTING PARAPET J2**  
1 1/2" = 1'-0"

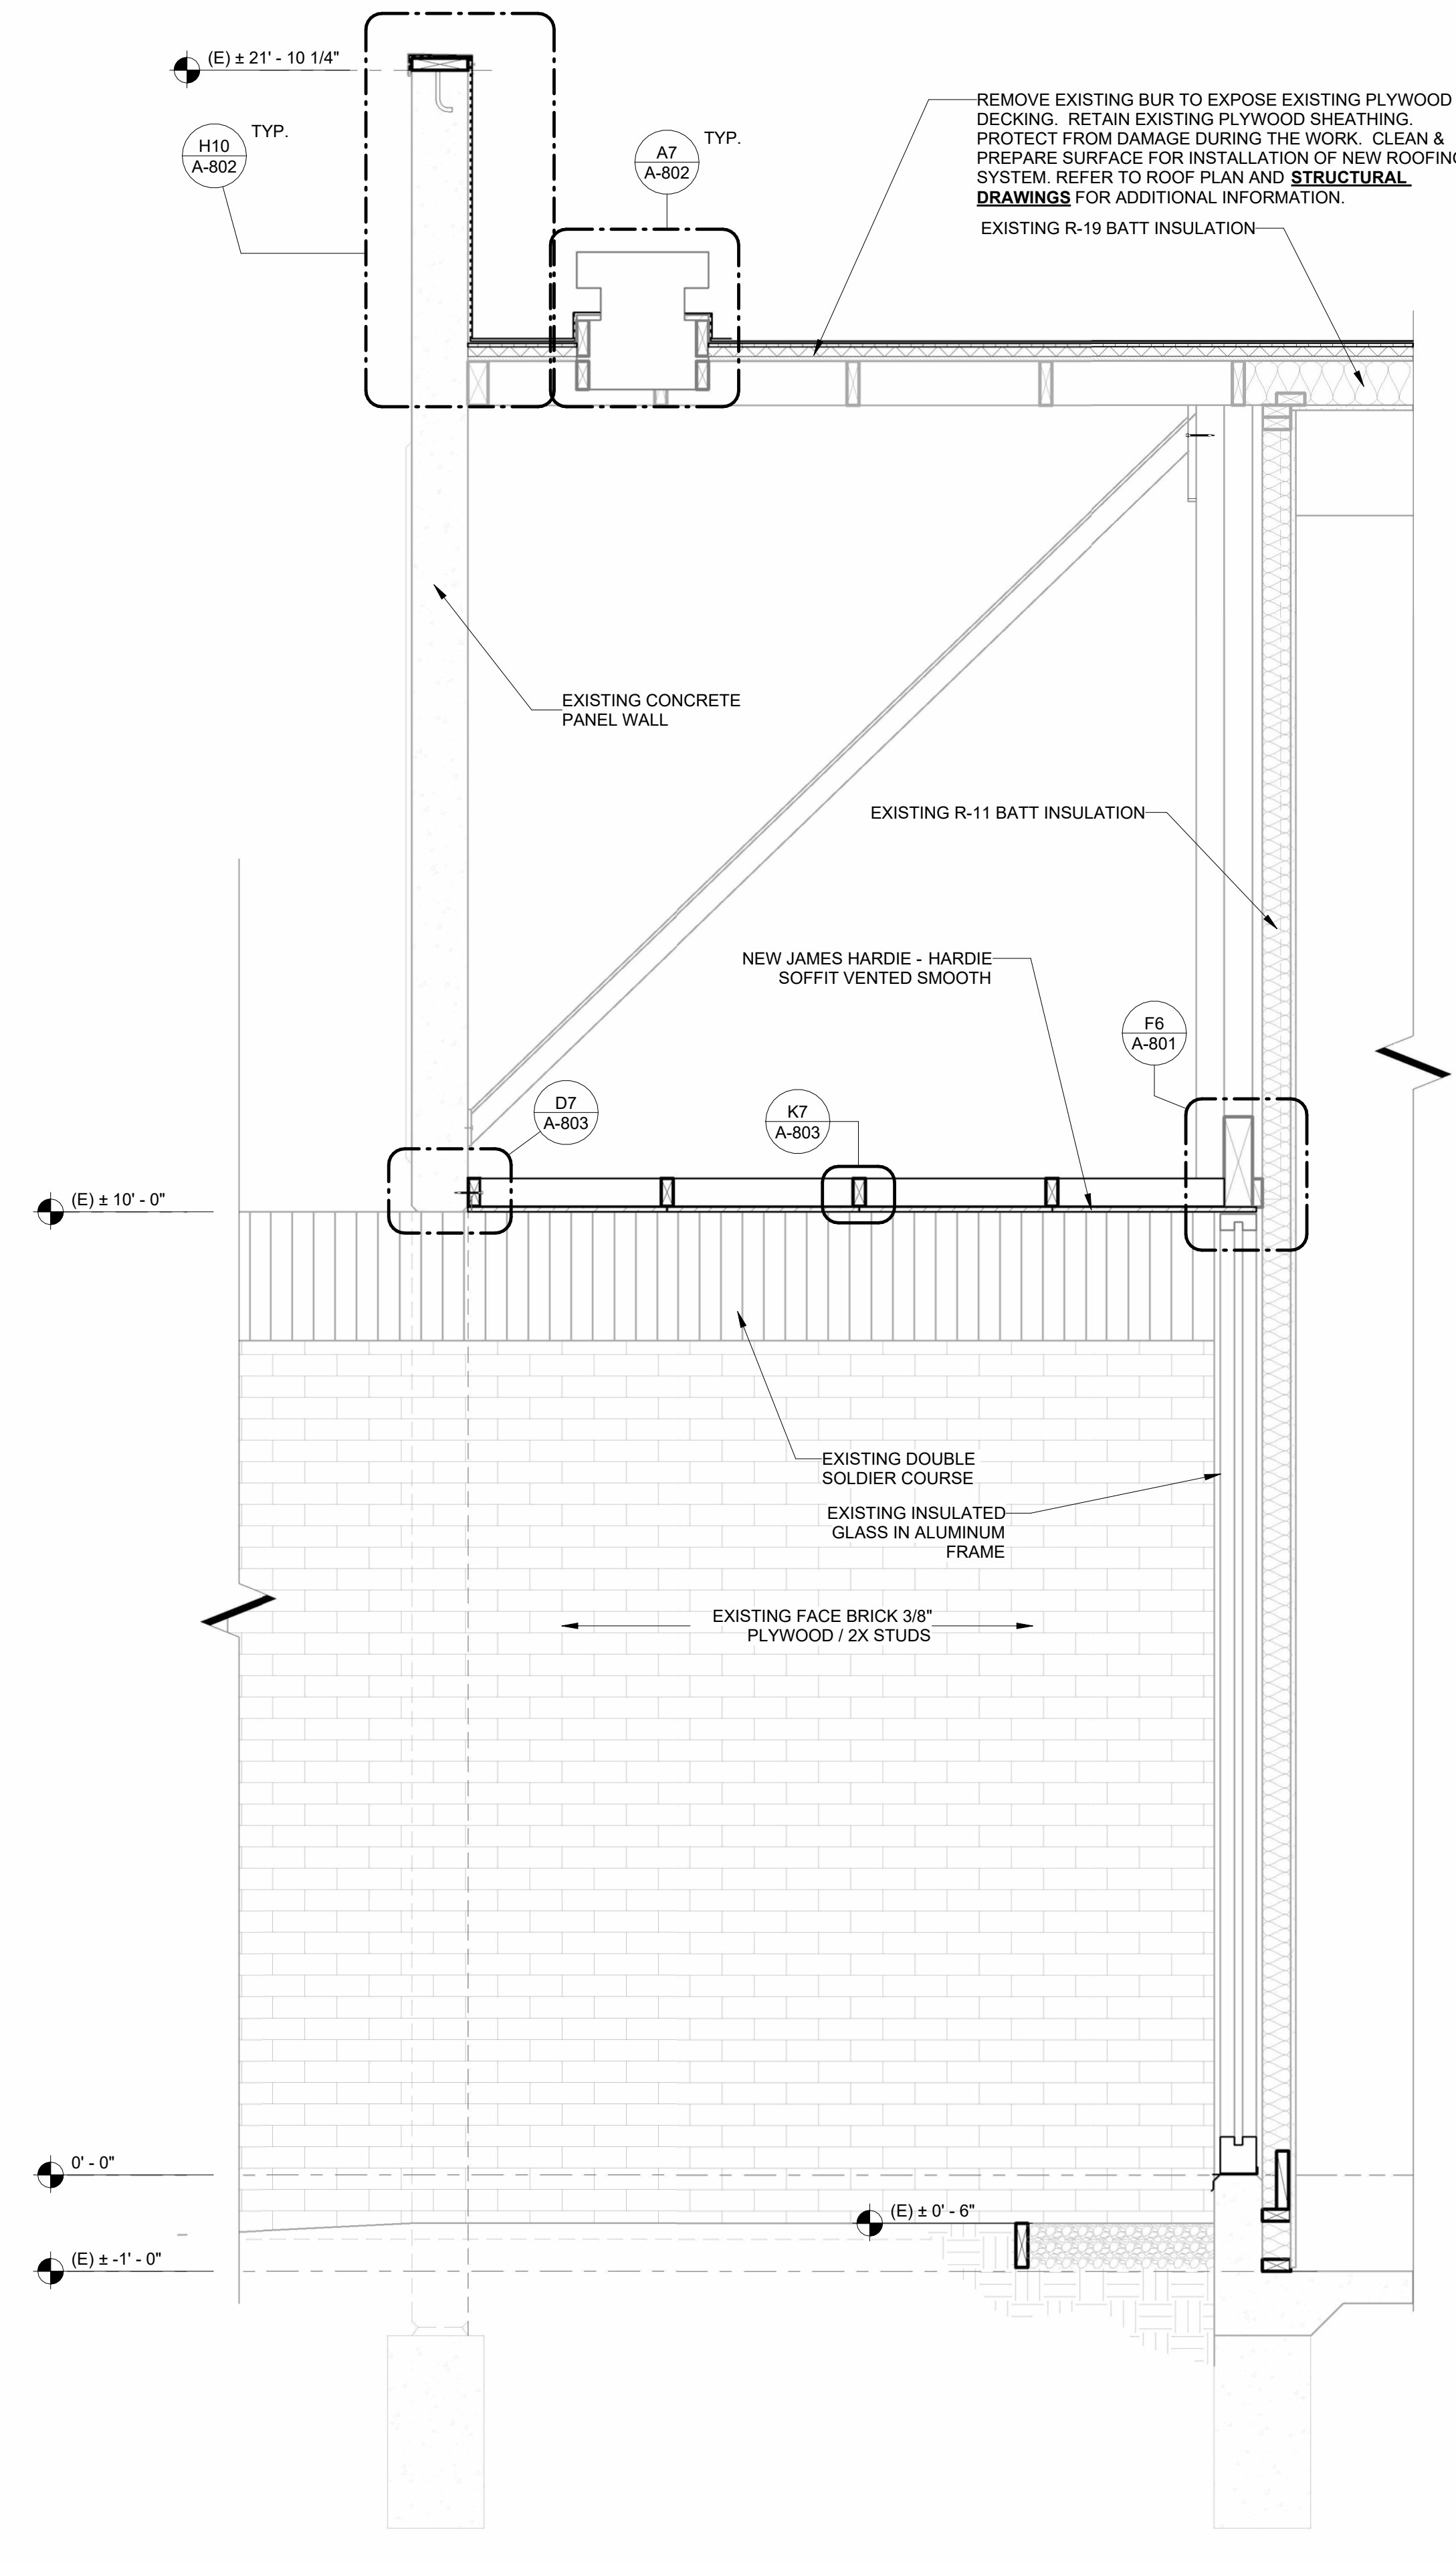

**TYPICAL WALL SECTION D A2**  
3/4" = 1'-0"

- GENERAL NOTES**
1. REFER TO STRUCTURAL AND MECHANICAL DRAWINGS FOR ADDITIONAL INFORMATION.
  2. FIELD VERIFY EXISTING BRICK VENEER CONDITION.
    - A. IDENTIFY AND PATCH ALL CRACKS IN THE EXISTING BRICK VENEER USING APPROPRIATE MATERIALS AND METHODS TO ENSURE A SEAMLESS REPAIR.
    - B. REPOINT EXISTING MORTAR JOINTS WHERE NECESSARY TO RESTORE THE INTEGRITY AND APPEARANCE OF THE BRICK VENEER. MATCH THE COLOR, TEXTURE, AND COMPOSITION OF THE EXISTING MORTAR.
    - C. REPAIR ANY DAMAGED BRICKS IN THE VENEER. USE BRICKS THAT MATCH THE EXISTING IN SIZE, COLOR, AND TEXTURE TO MAINTAIN A UNIFORM APPEARANCE.
    - D. REPLACE ANY MISSING BRICKS WITH NEW BRICKS THAT MATCH THE EXISTING ONES IN SIZE, COLOR, AND TEXTURE. ENSURE REPLACEMENTS ARE PROPERLY INTEGRATED INTO THE EXISTING VENEER.
    - E. IDENTIFY AND REMOVE ALL DAMAGED SECTIONS OF THE SHEET MEMBRANE WATERPROOFING. CLEAN AND PREPARE THE UNDERLYING SURFACES TO ENSURE PROPER ADHESION OF THE NEW WATERPROOFING MATERIAL. APPLY NEW SHEET MEMBRANE WATERPROOFING AS PER MANUFACTURER'S SPECIFICATIONS AND ENSURE ALL SEAMS AND JOINTS ARE PROPERLY SEALED TO PROVIDE A CONTINUOUS, WATERTIGHT BARRIER.
  3. EXISTING WINDOWS TO REMAIN. ALL WINDOW MODIFICATIONS, REPAIRS AND/OR REPLACEMENTS INCLUDING REPLACEMENT OF WEATHERSTRIPPING, SEALANTS AND CAULKING WILL BE UNDER A SEPARATE CONTRACT.
  4. FIELD VERIFY ALL EXISTING EXTERIOR JOINTS AND JUNCTIONS OF DIFFERING MATERIALS, INCLUDING BUT NOT LIMITED TO INTERSECTIONS OF BRICK AND CONCRETE WALLS. CLEAN AND PREPARE SURFACES THOROUGHLY. APPLY NEW SEALANT AS REQUIRED TO ENSURE A WATERTIGHT ASSEMBLY.
  5. SEALANT AT MATERIAL INTERSECTIONS: PROVIDE APPROPRIATE SEALANT AT ALL INTERSECTIONS OF DIFFERENT MATERIALS TO ENSURE A WATERTIGHT AND DURABLE CONNECTION. USE SEALANTS THAT ARE COMPATIBLE WITH ALL ADJOINING MATERIALS AND MATCH THE COLOR AND TEXTURE OF THE SURROUNDING AREAS.
  6. UPON COMPLETION OF ALL REPAIRS, CONDUCT A THOROUGH INSPECTION TO ENSURE ALL WORK HAS BEEN COMPLETED SATISFACTORILY AND THAT THE BRICK VENEER FINISH HAS BEEN RESTORED TO ITS ORIGINAL CONDITION OR BETTER.
  7. REFER TO SPECIFICATIONS FOR ADDITIONAL INFORMATION.


**APPROVED**  
Sep 25 2024  
COUNTY OF FRESNO  
DEVELOPMENT SERVICES

PROJECT


**ROOF REPLACEMENT & FACADE REPAIRS**

5555 E Olive Avenue, Fresno, CA 93727

CLIENT



ARCHITECT




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robina@rwaarchitect.com

SEAL & SIGNATURE



CONSULTANT

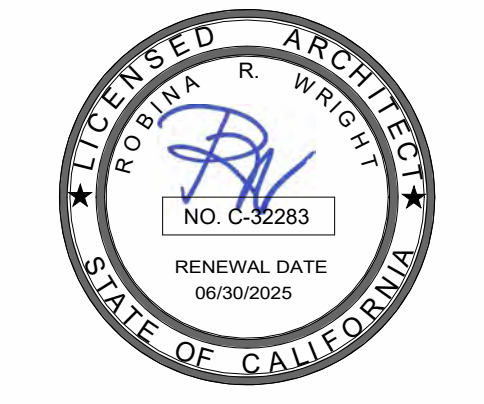UPDATE  
OCTOBER 21, 2024

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TITLE	

TITLE

**WALL SECTIONS**

SCALE: As indicated

PO #491344


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ISSUE DATE MAY 23, 2024	JOB NUMBER 2024_10
DRAWN BY Author	CHECKED BY Checker




DETAIL - REMOVED


DETAIL - REMOVED

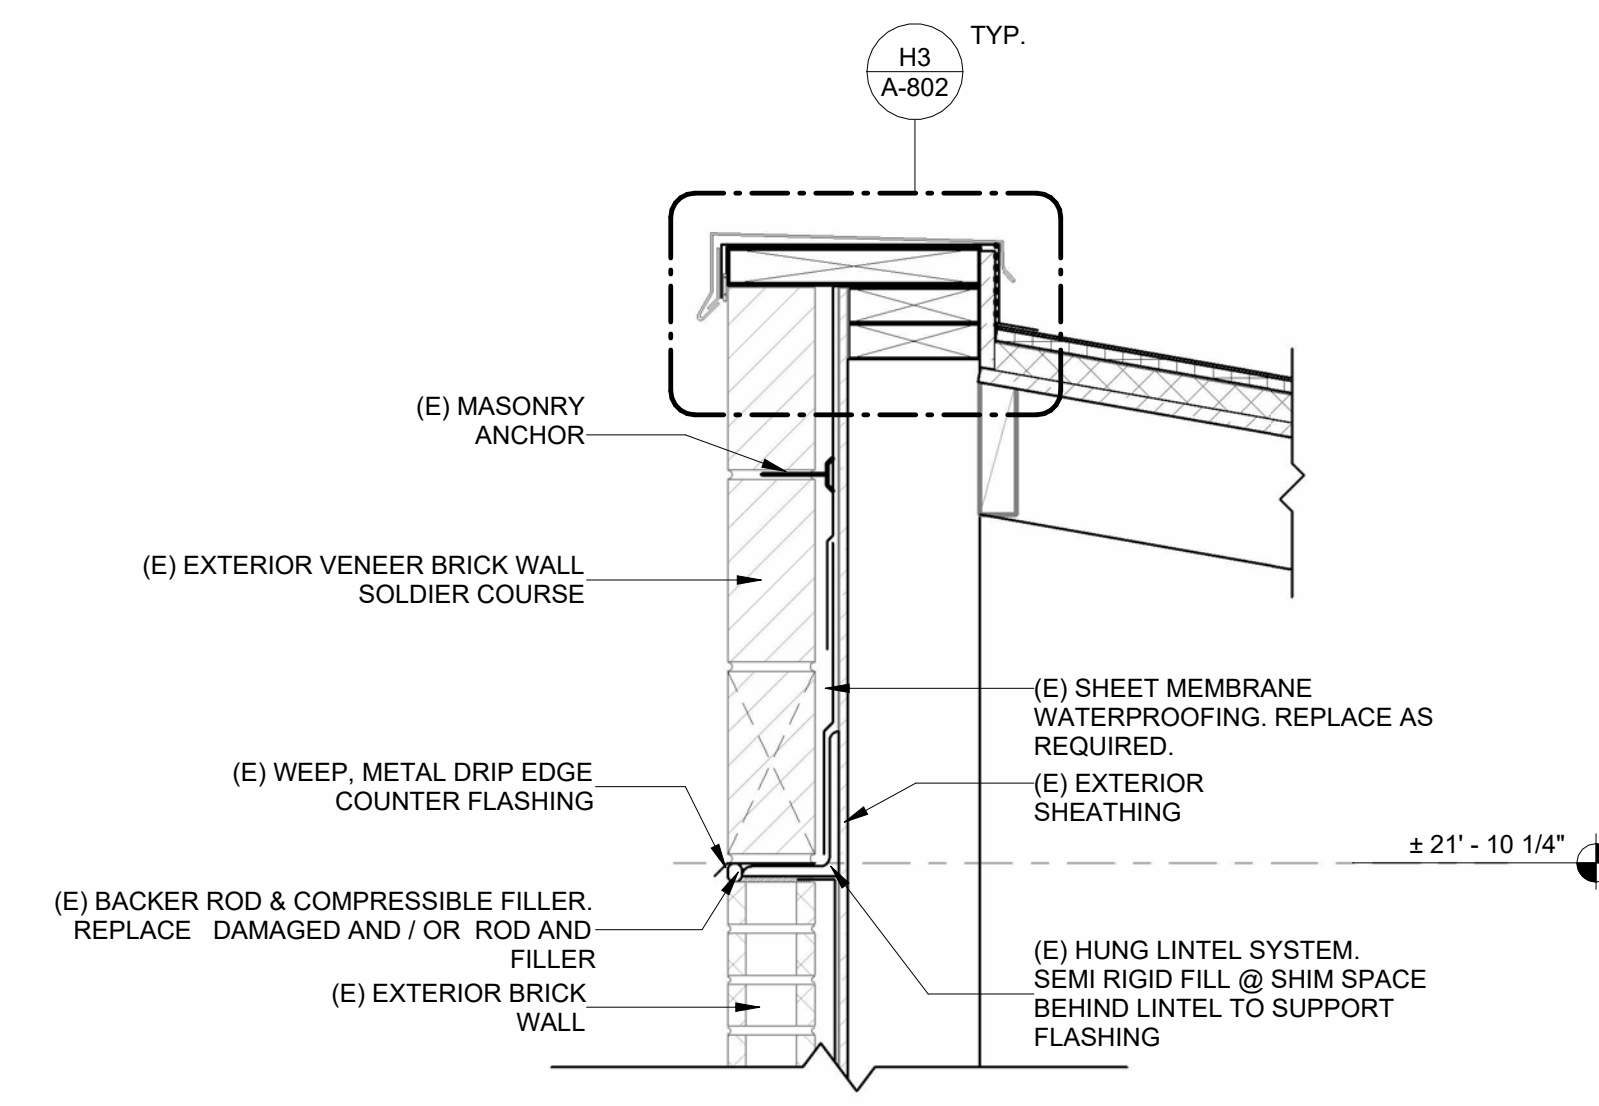

(E) BRICK VENEER PARAPET DETAIL 1 1/2" = 1'-0" J2

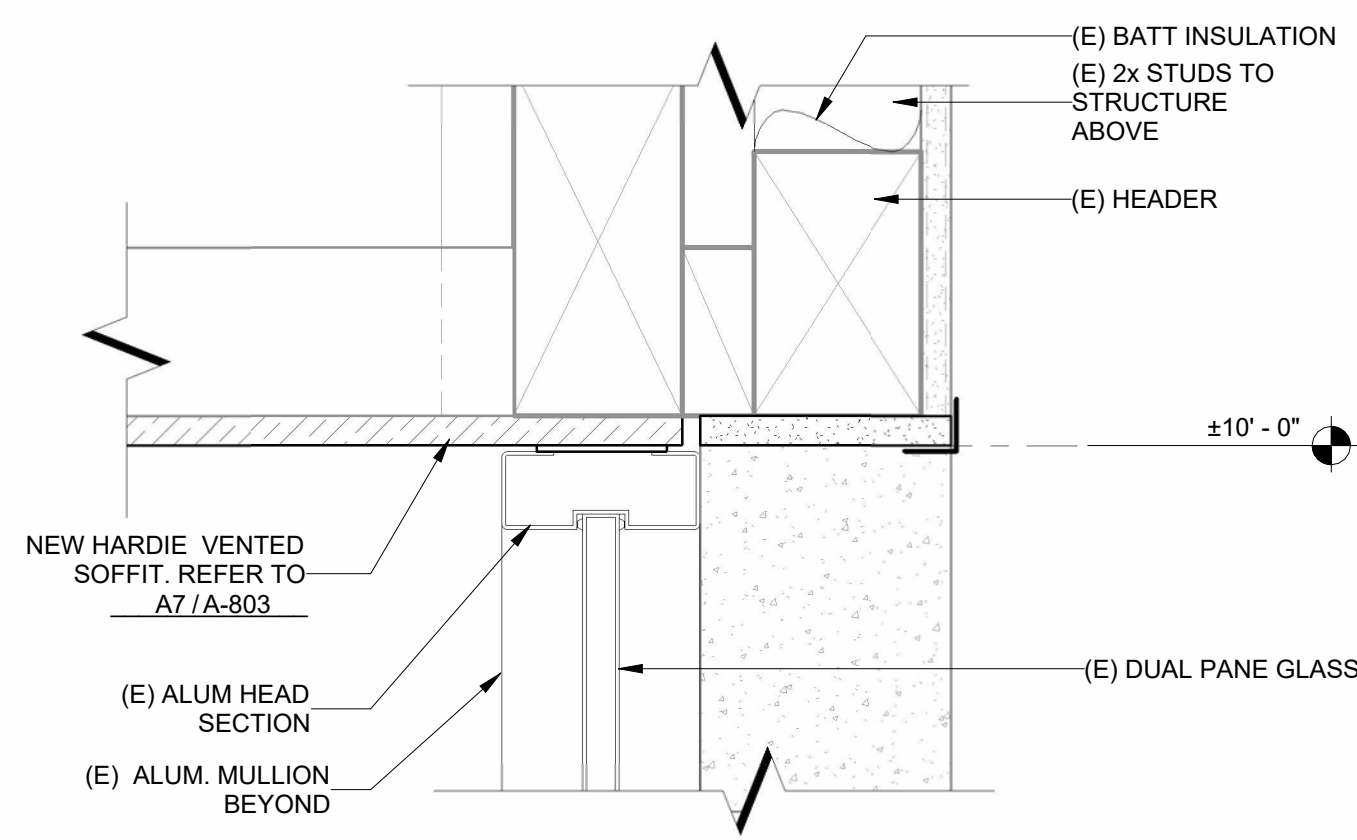


(E) HEAD @ DUAL PANE GLASS 3" = 1'-0" F10

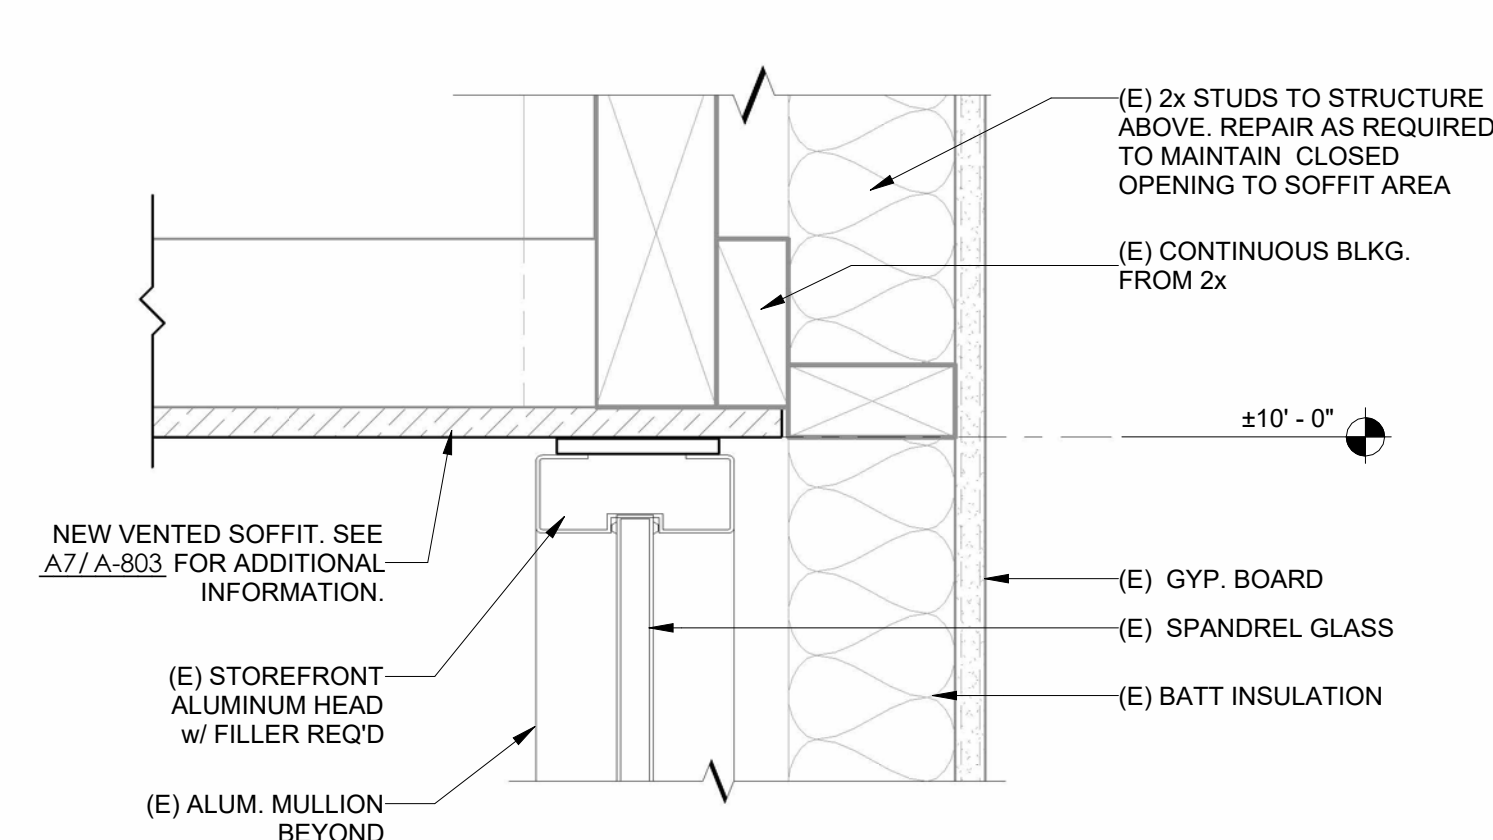

(E) TYP. HEAD @ WINDOW WALL 3" = 1'-0" F6

DETAIL - REMOVED

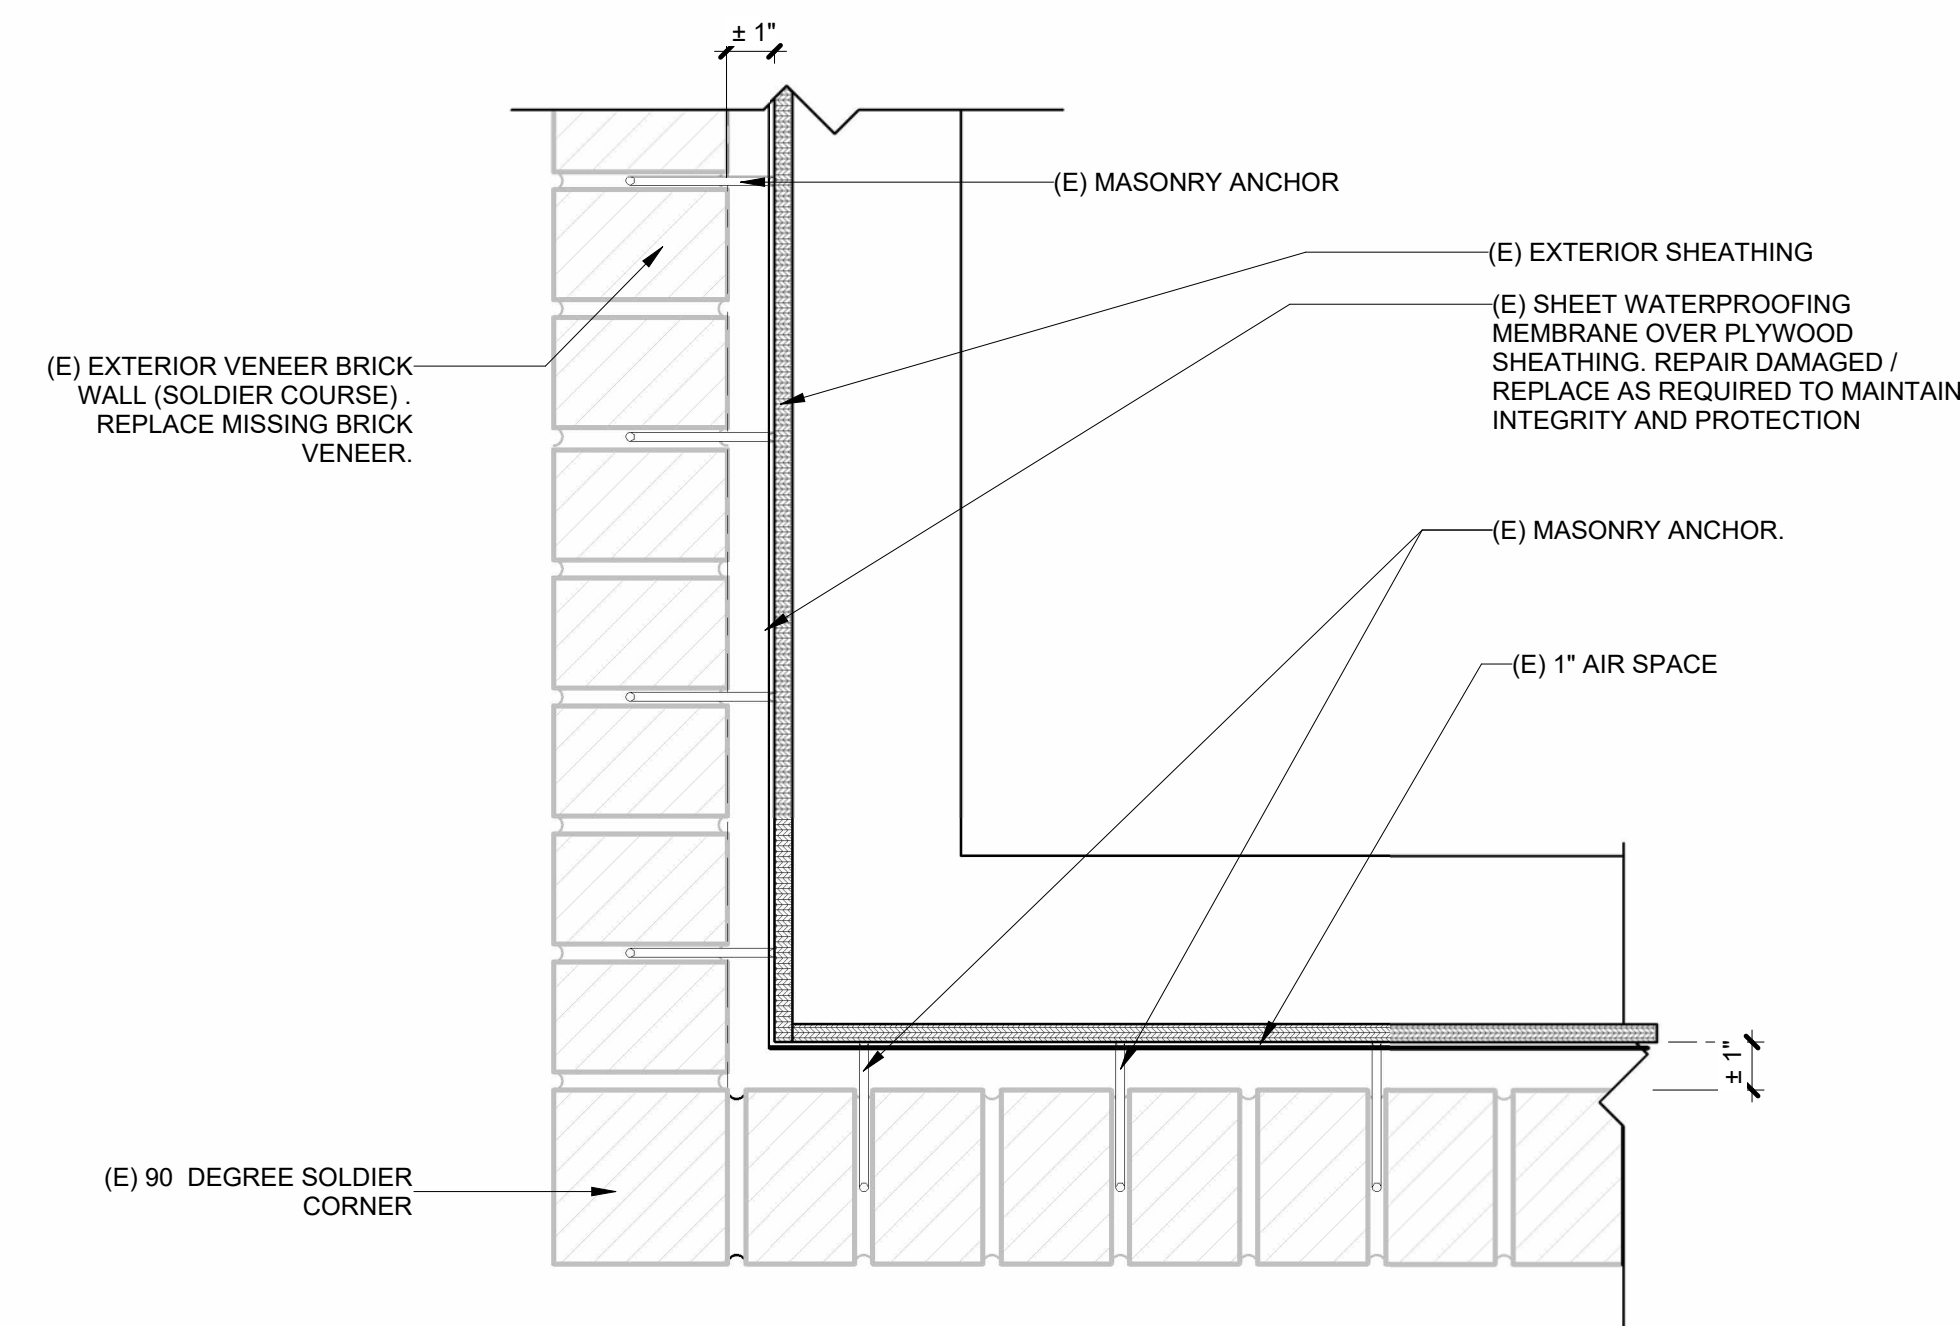

(E) SOLDIER COURSE BRICKWORK @ CORNER 3" = 1'-0" C2

DETAIL - REMOVED

DETAIL - REMOVED

DETAIL - REMOVED

DETAIL - REMOVED

DETAIL - REMOVED


GENERAL NOTES

- 1. REFER TO STRUCTURAL AND MECHANICAL DRAWINGS FOR ADDITIONAL INFORMATION.
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7. REFER TO SPECIFICATIONS FOR ADDITIONAL INFORMATION.

APPROVED Sep 25 2024 COUNTY OF FRESNO DEVELOPMENT SERVICES

PROJECT ROOF REPLACEMENT & FACADE REPAIRS

5555 E Olive Avenue, Fresno, CA 93727

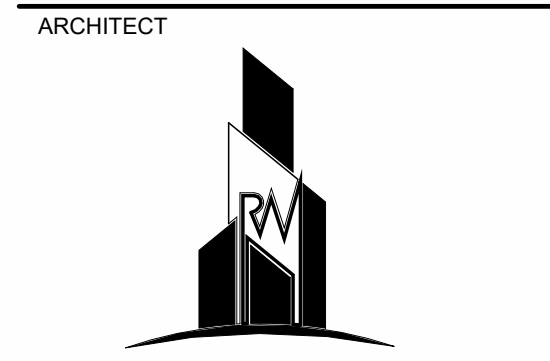

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SEAL & SIGNATURE



CONSULTANT

UPDATE OCTOBER 21, 2024

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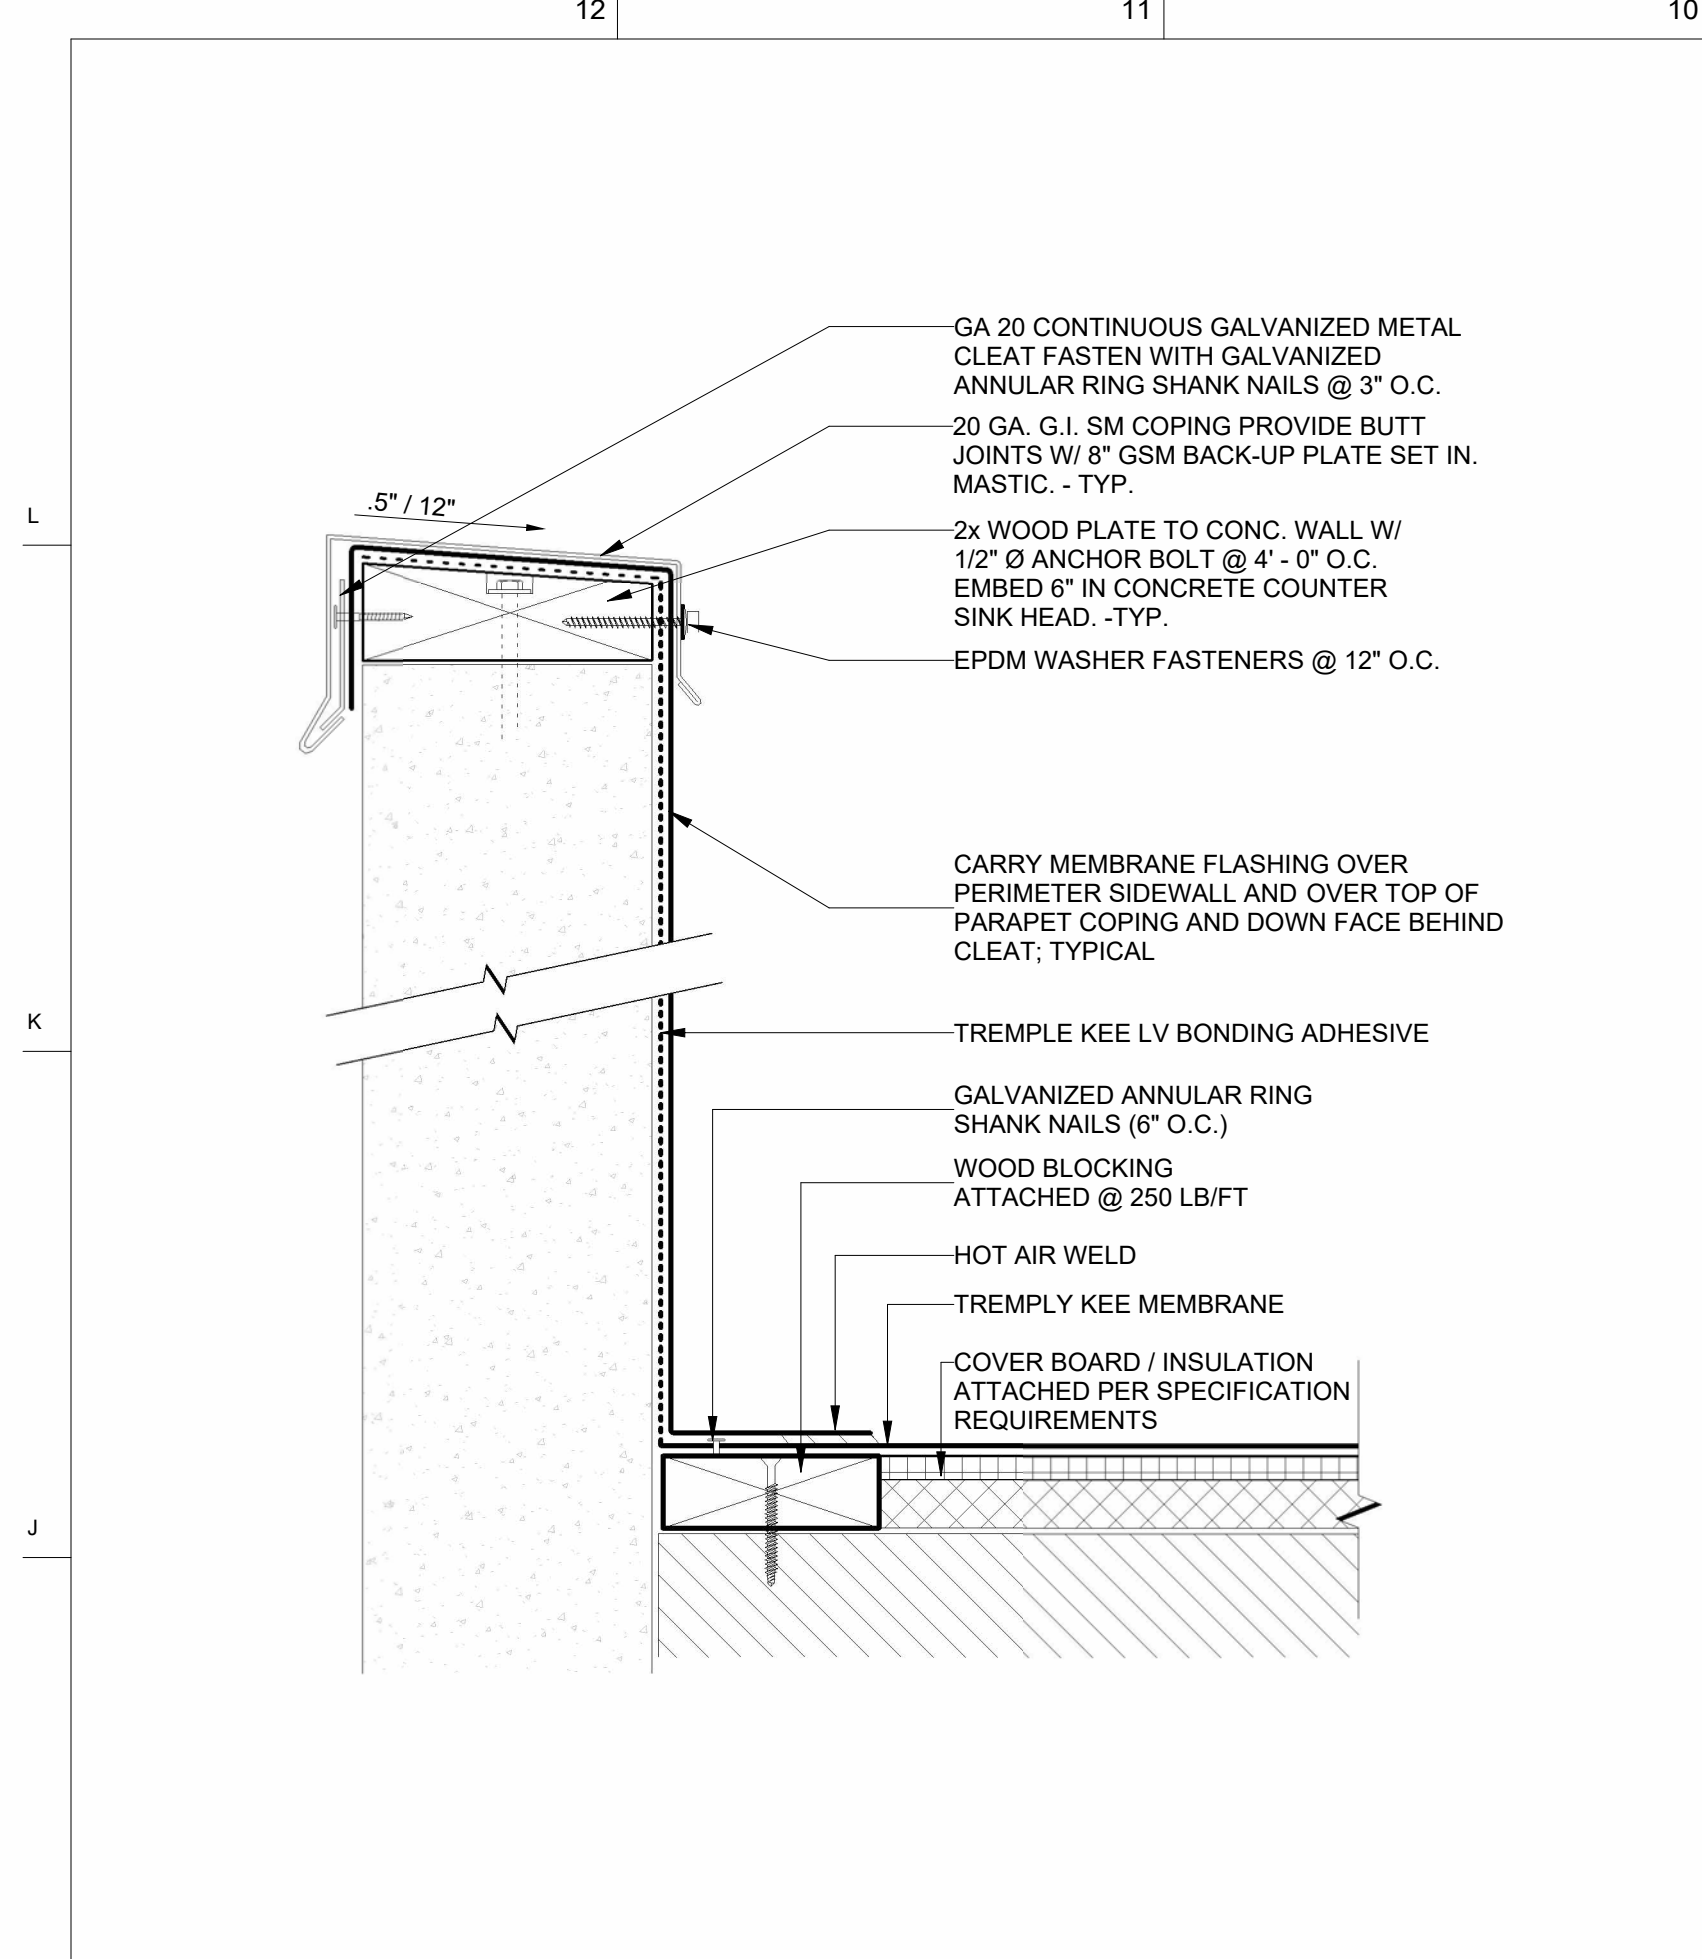
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ARCHITECTURAL DETAILS


SCALE As indicated PO #491344

A-801


ISSUE DATE MAY 23, 2024 JOB NUMBER 2024\_10 DRAWN BY Author CHECKED BY Checker




**WALL FLASHING WITH METAL CAP FLASHING H10**  
3" = 1'-0"

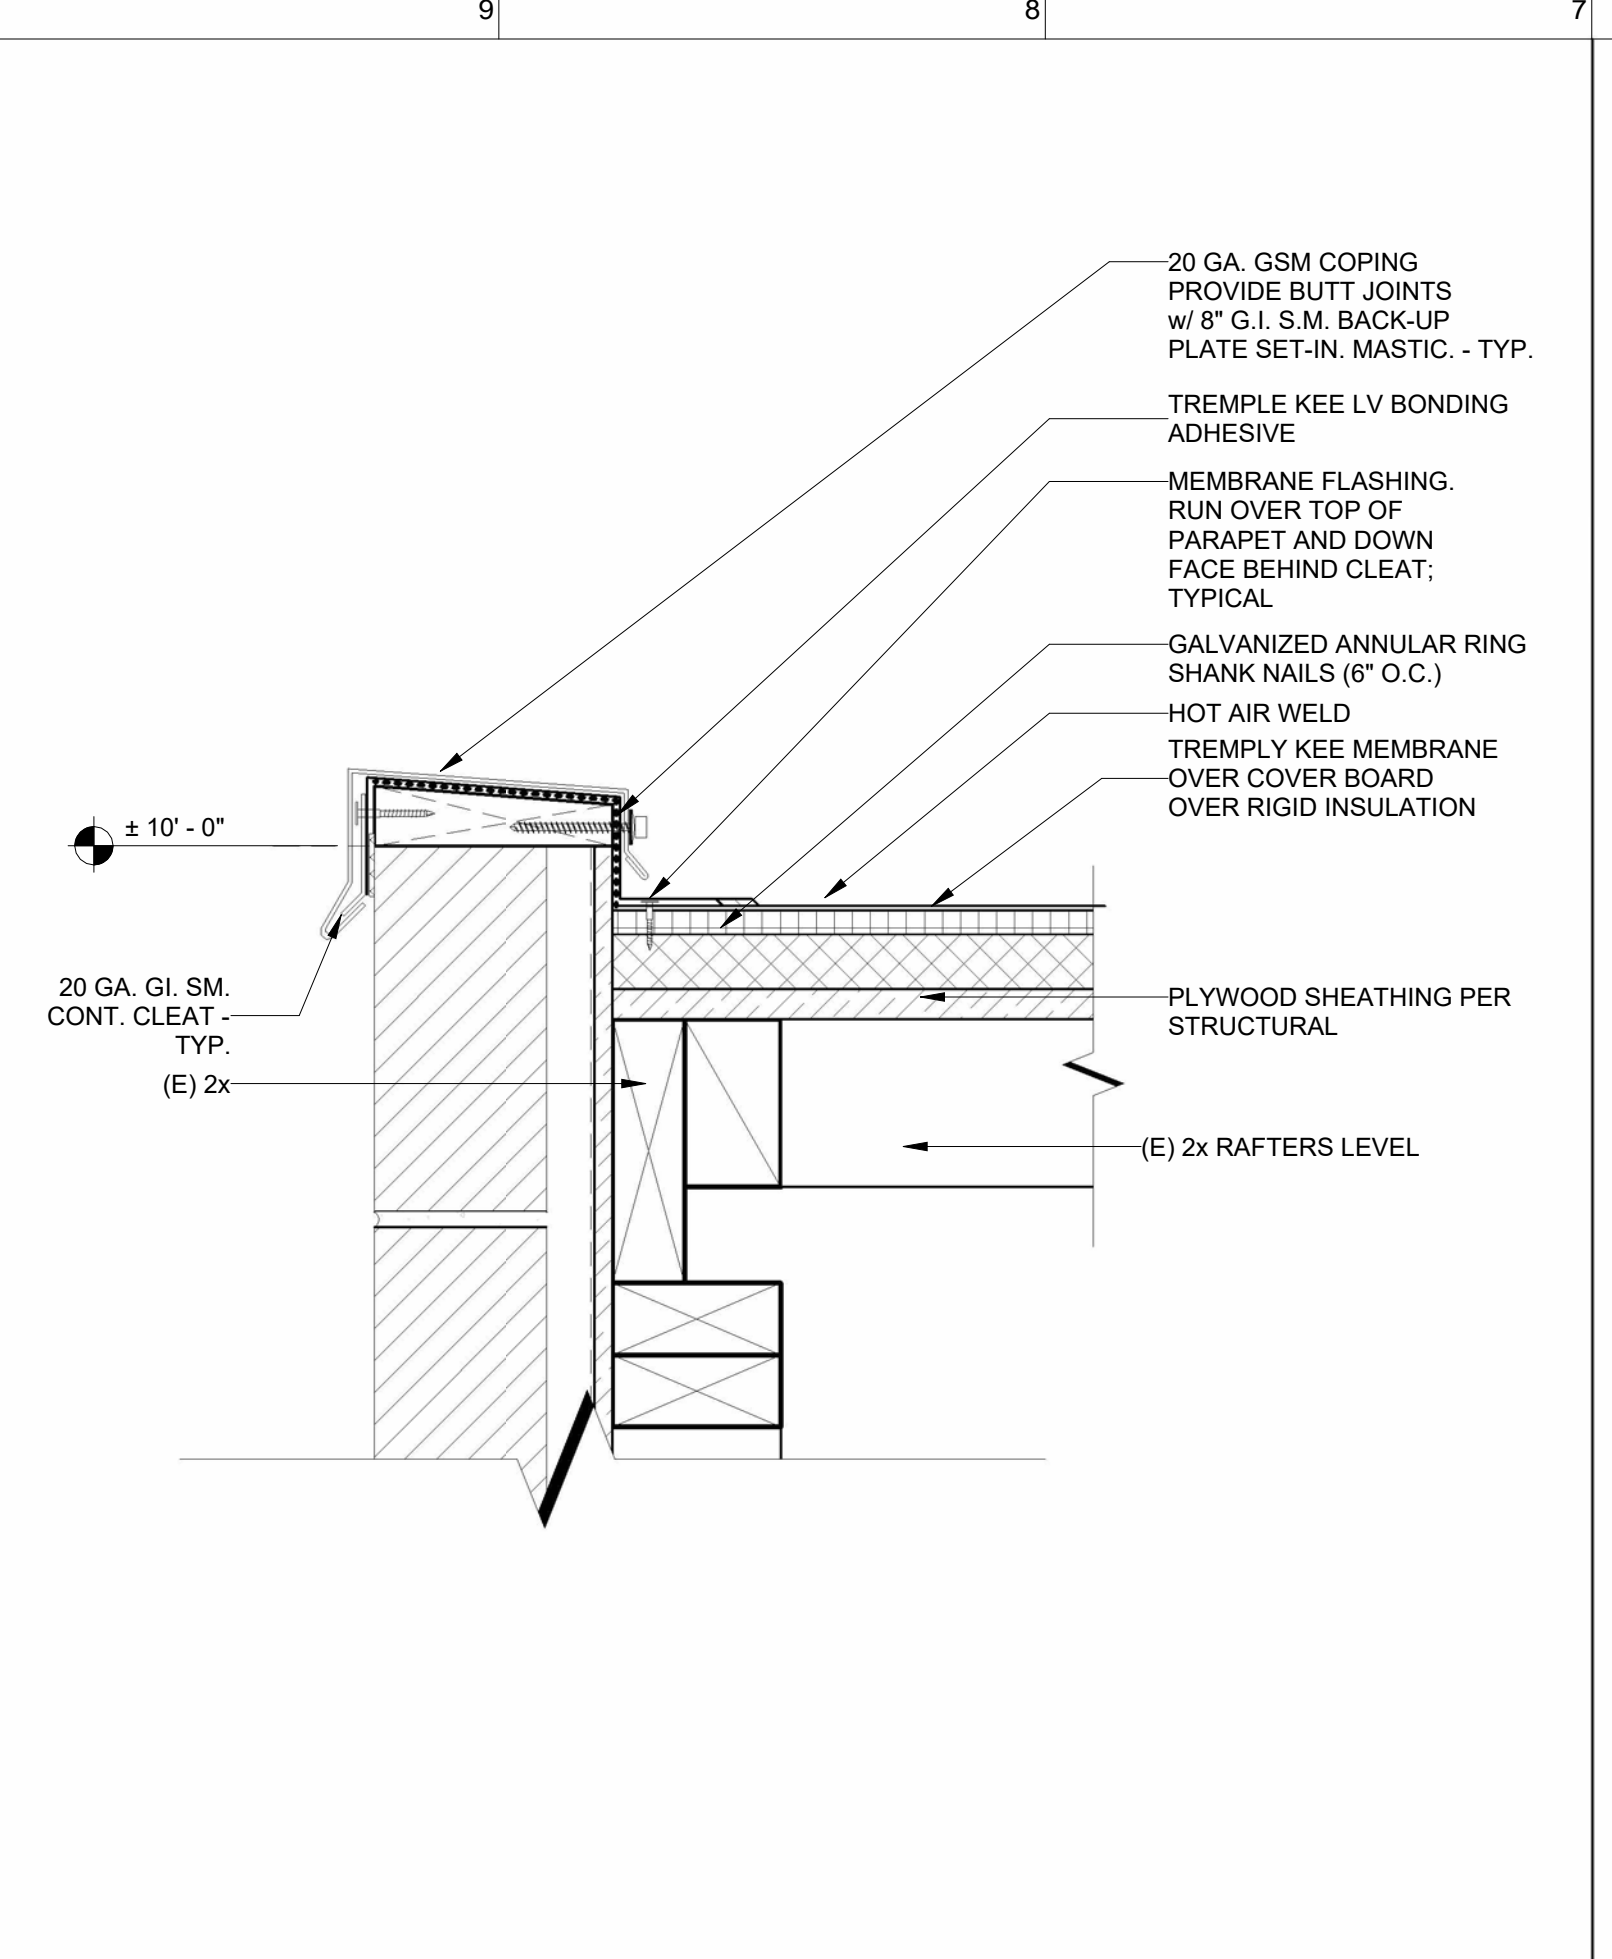


**ROOF EDGE FLASHING 2 H7**  
3" = 1'-0"

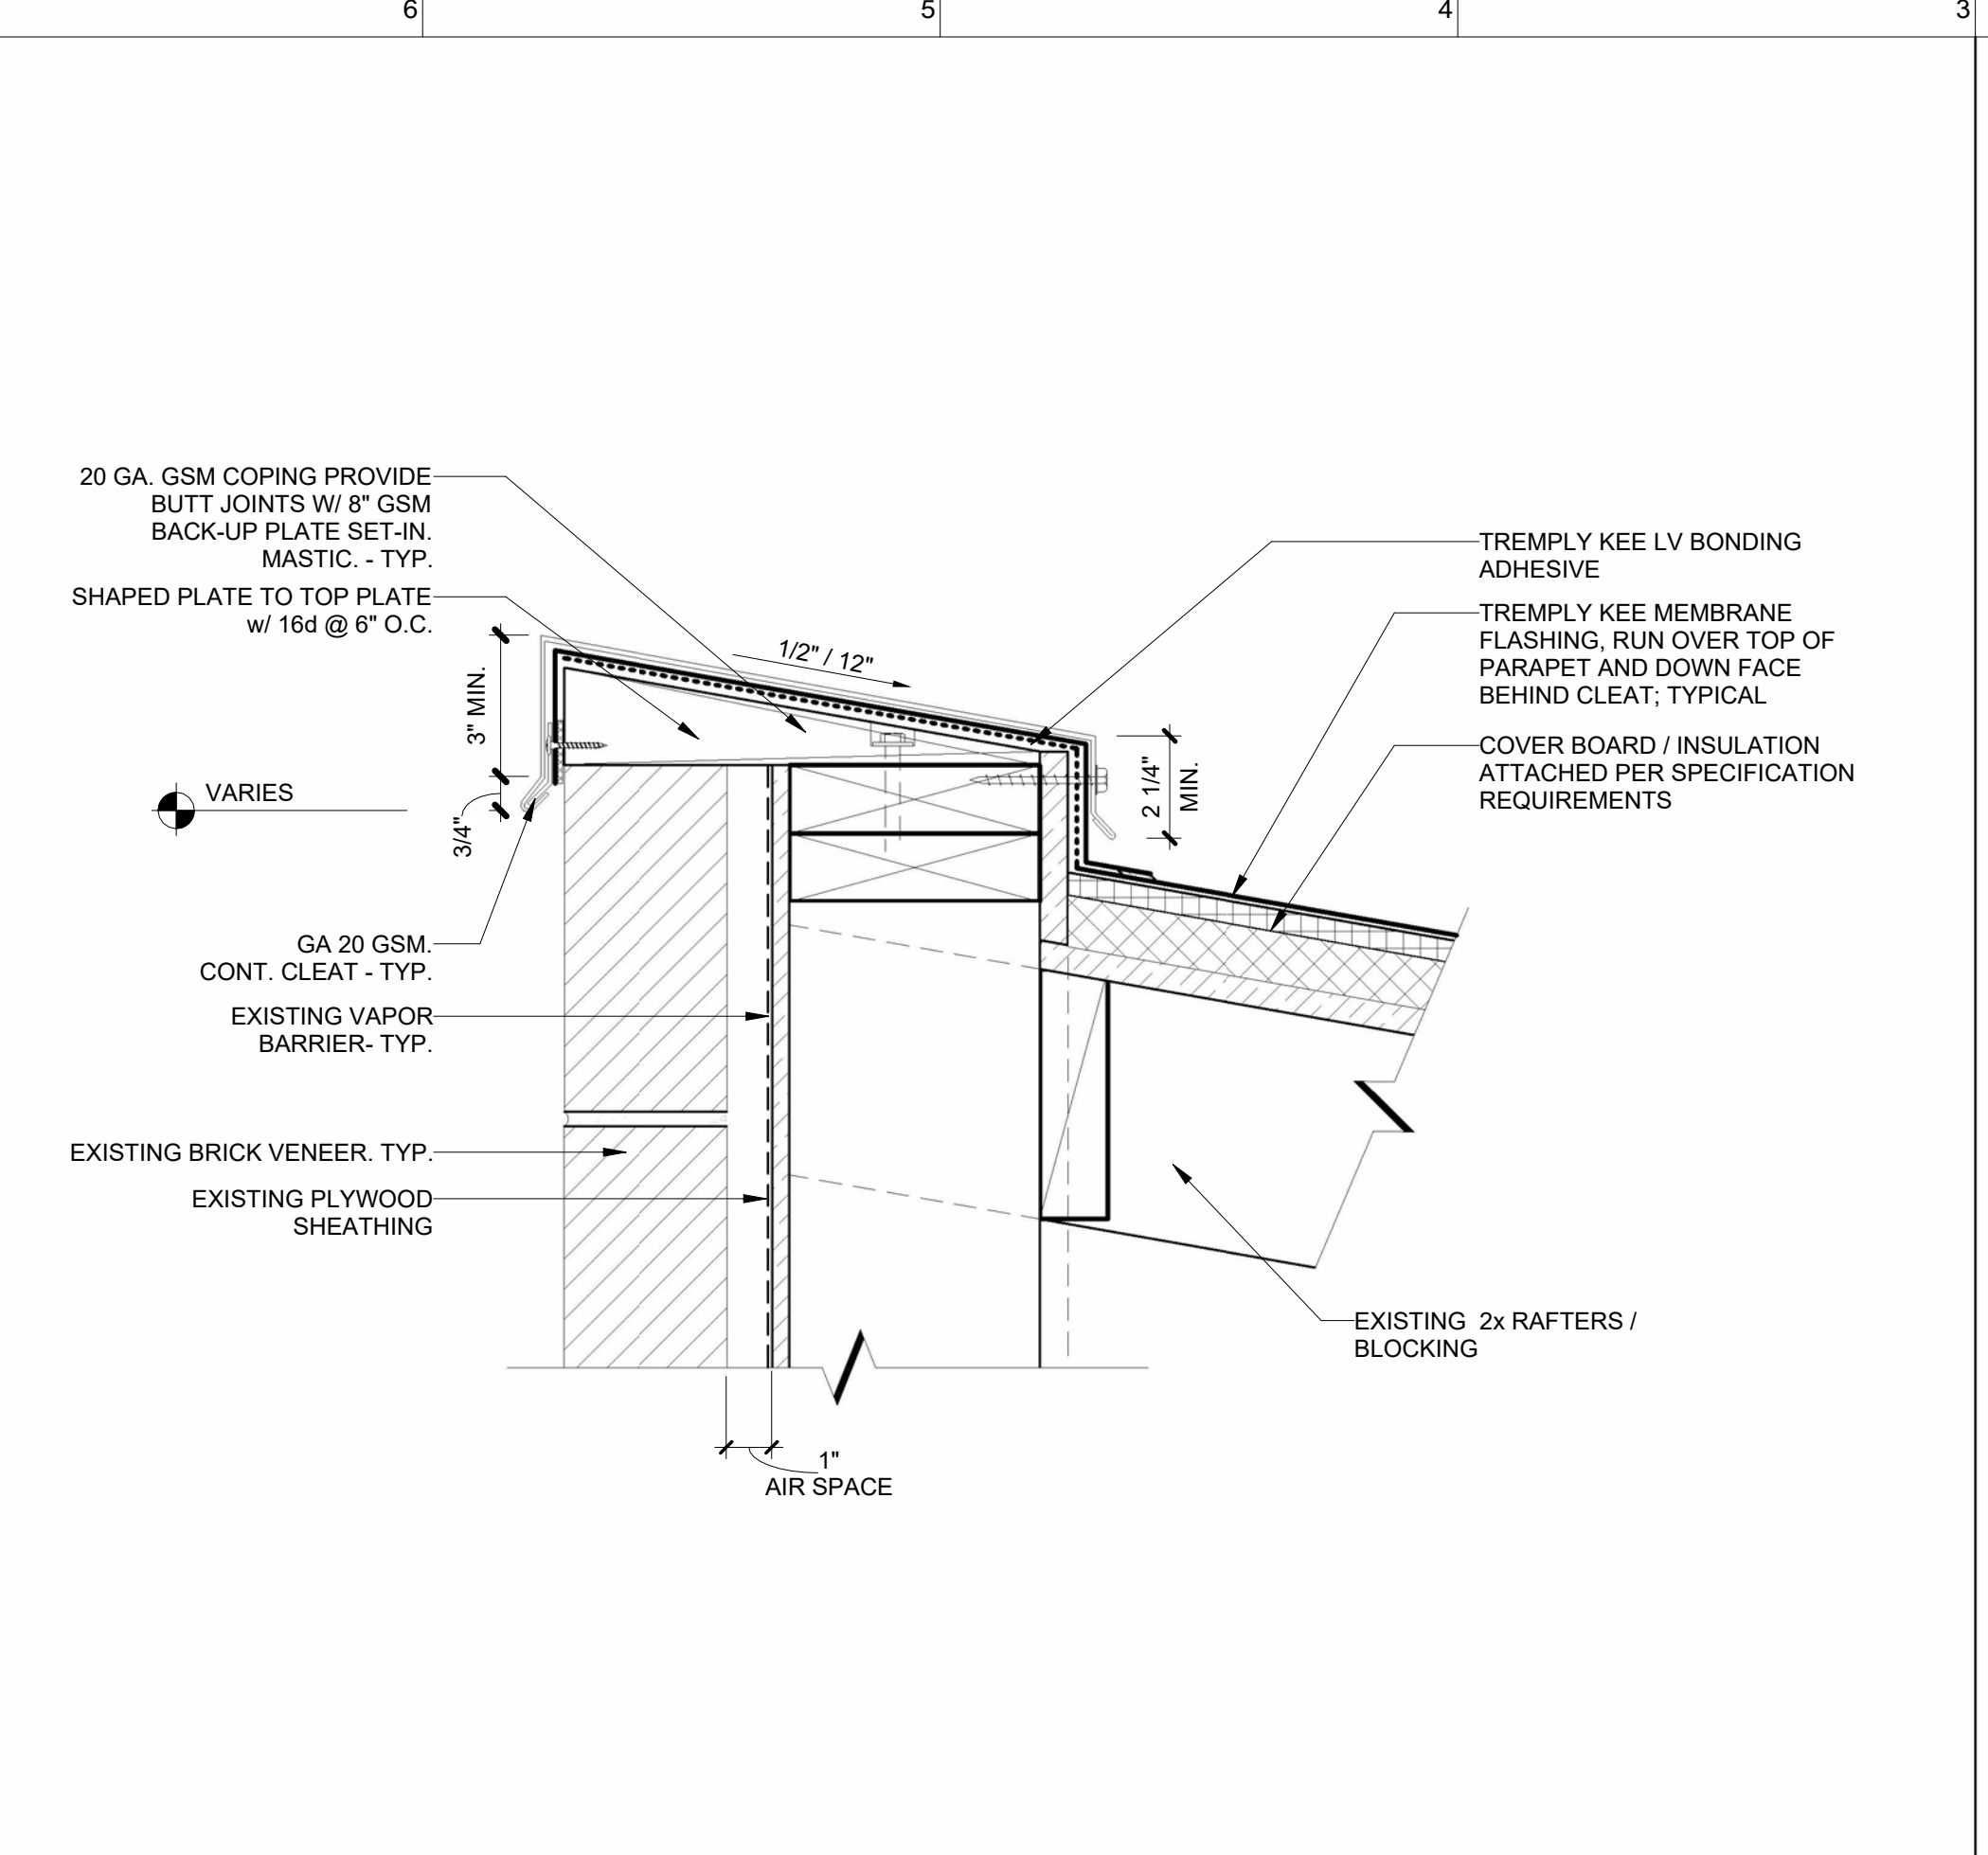


**METAL COPING DETAIL H3**  
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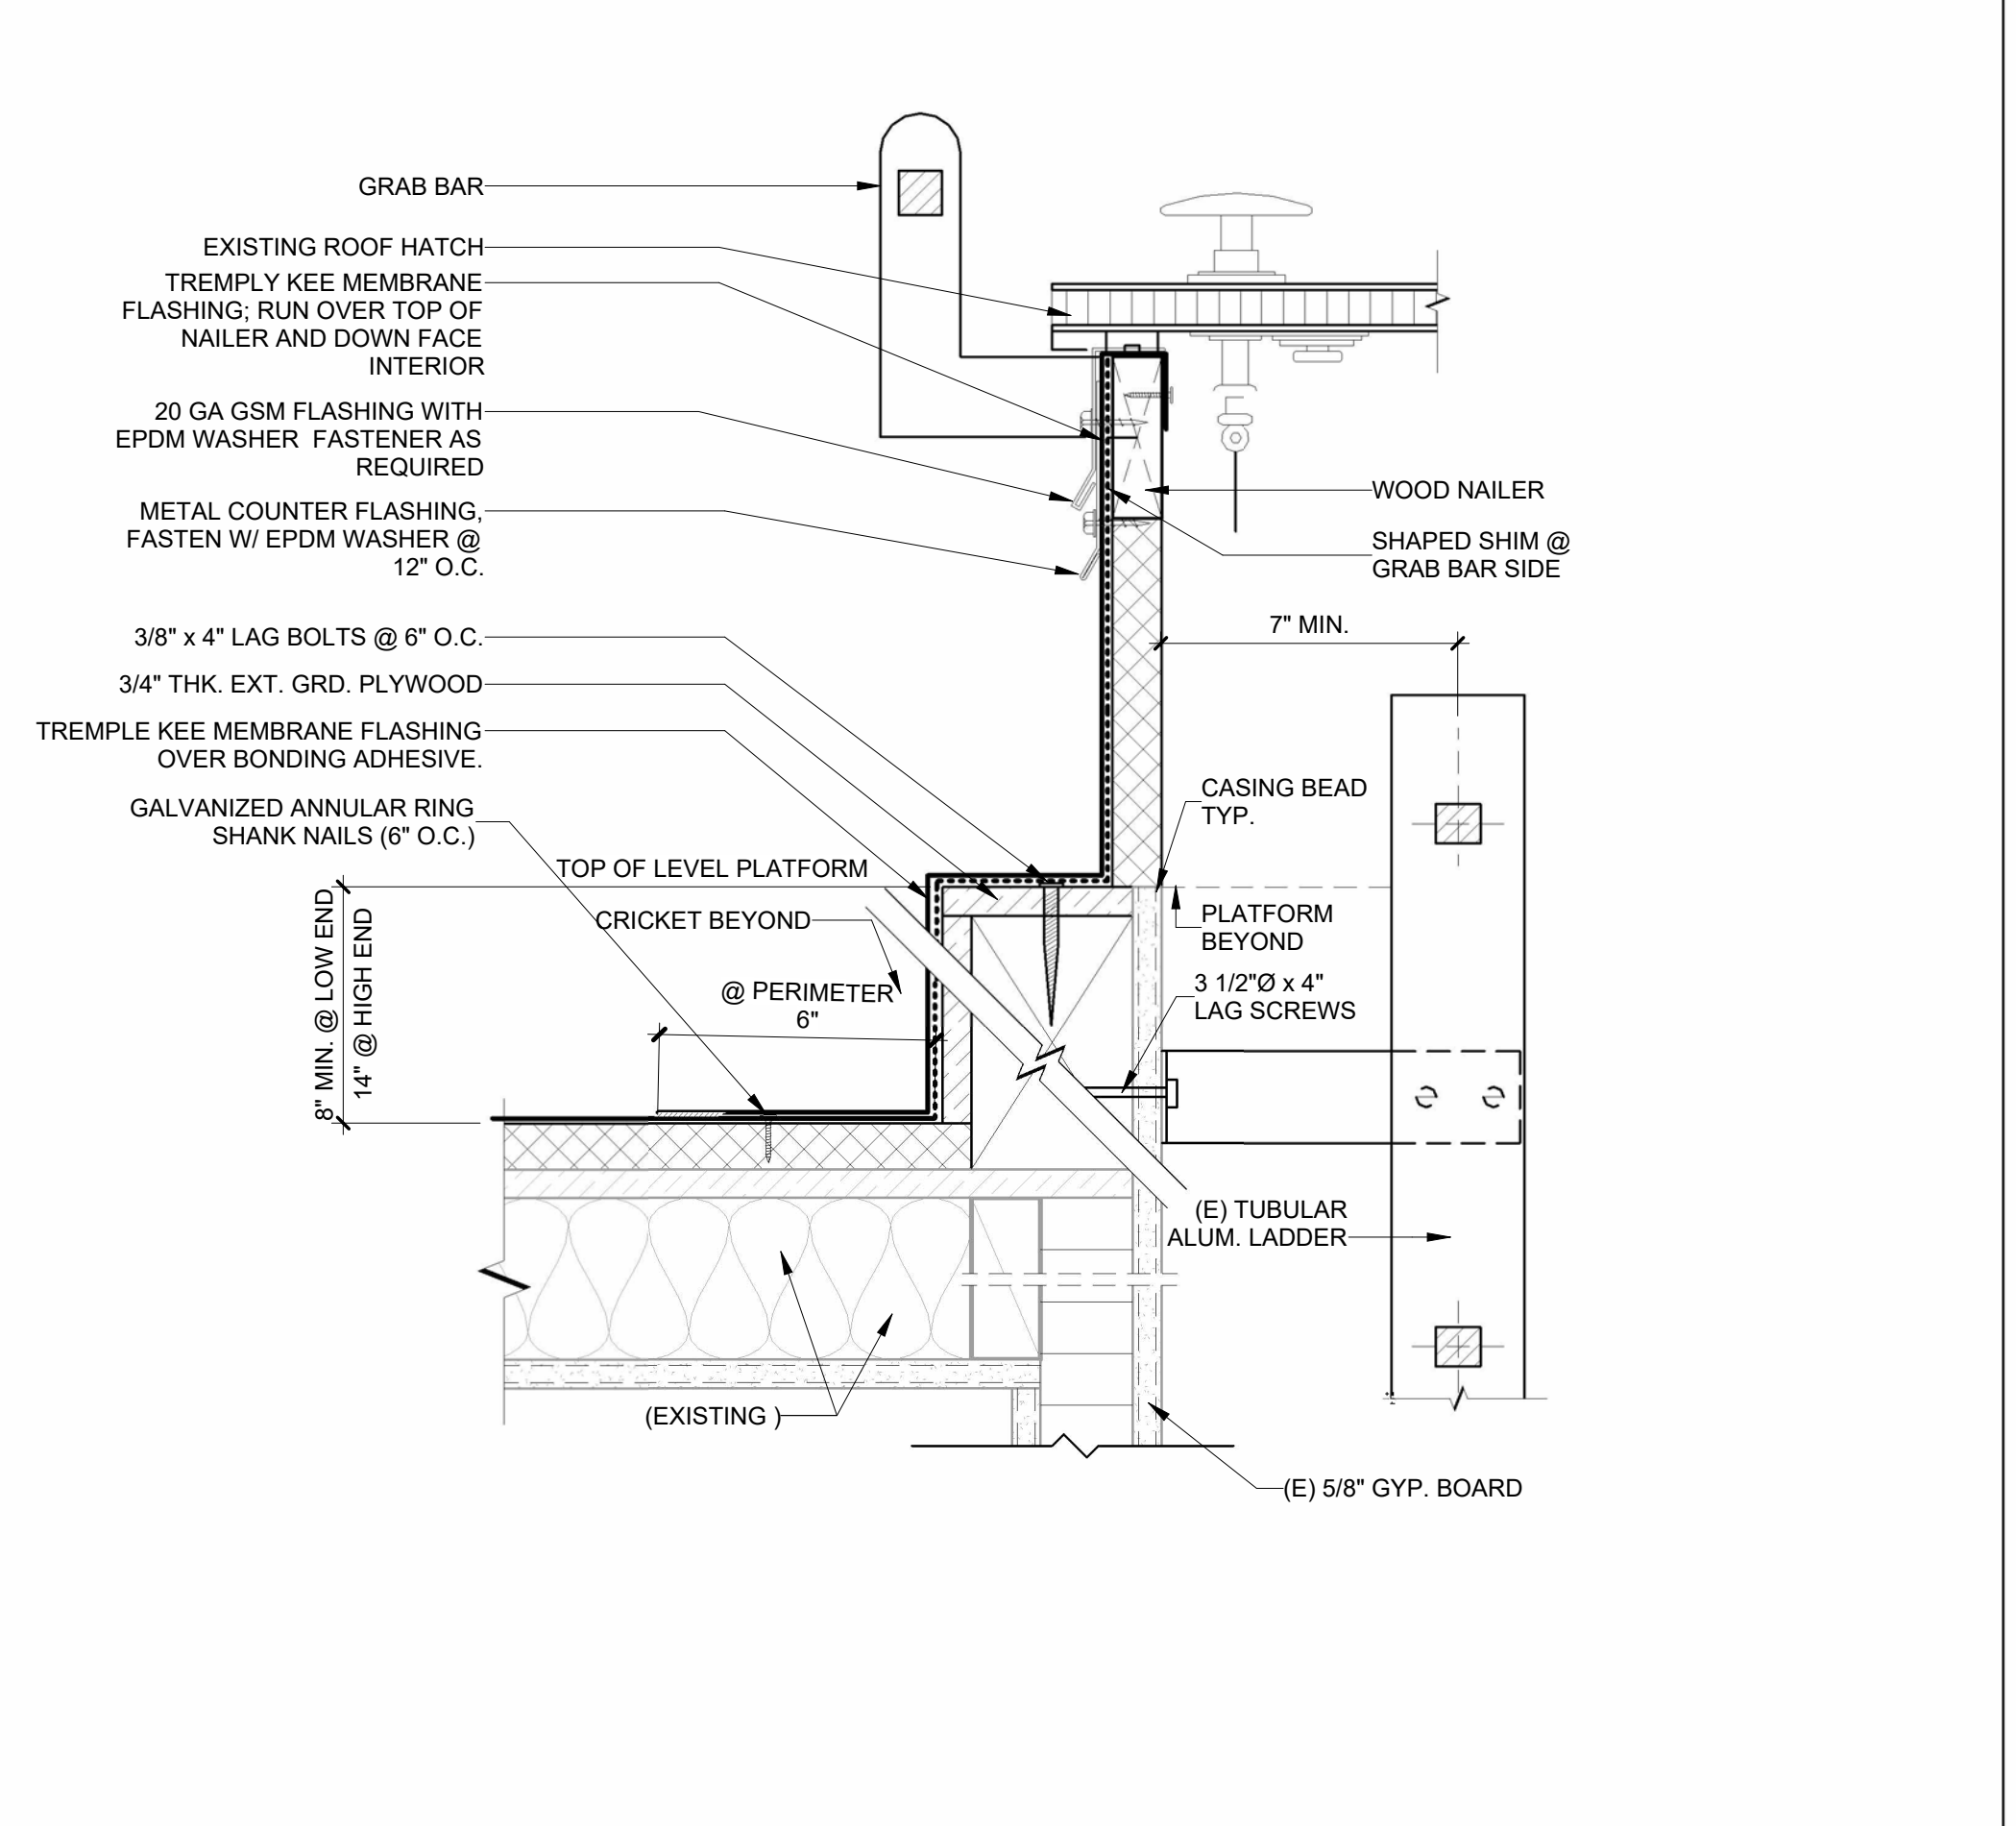
**ROOF EDGE FLASHING H1**  
3" = 1'-0"

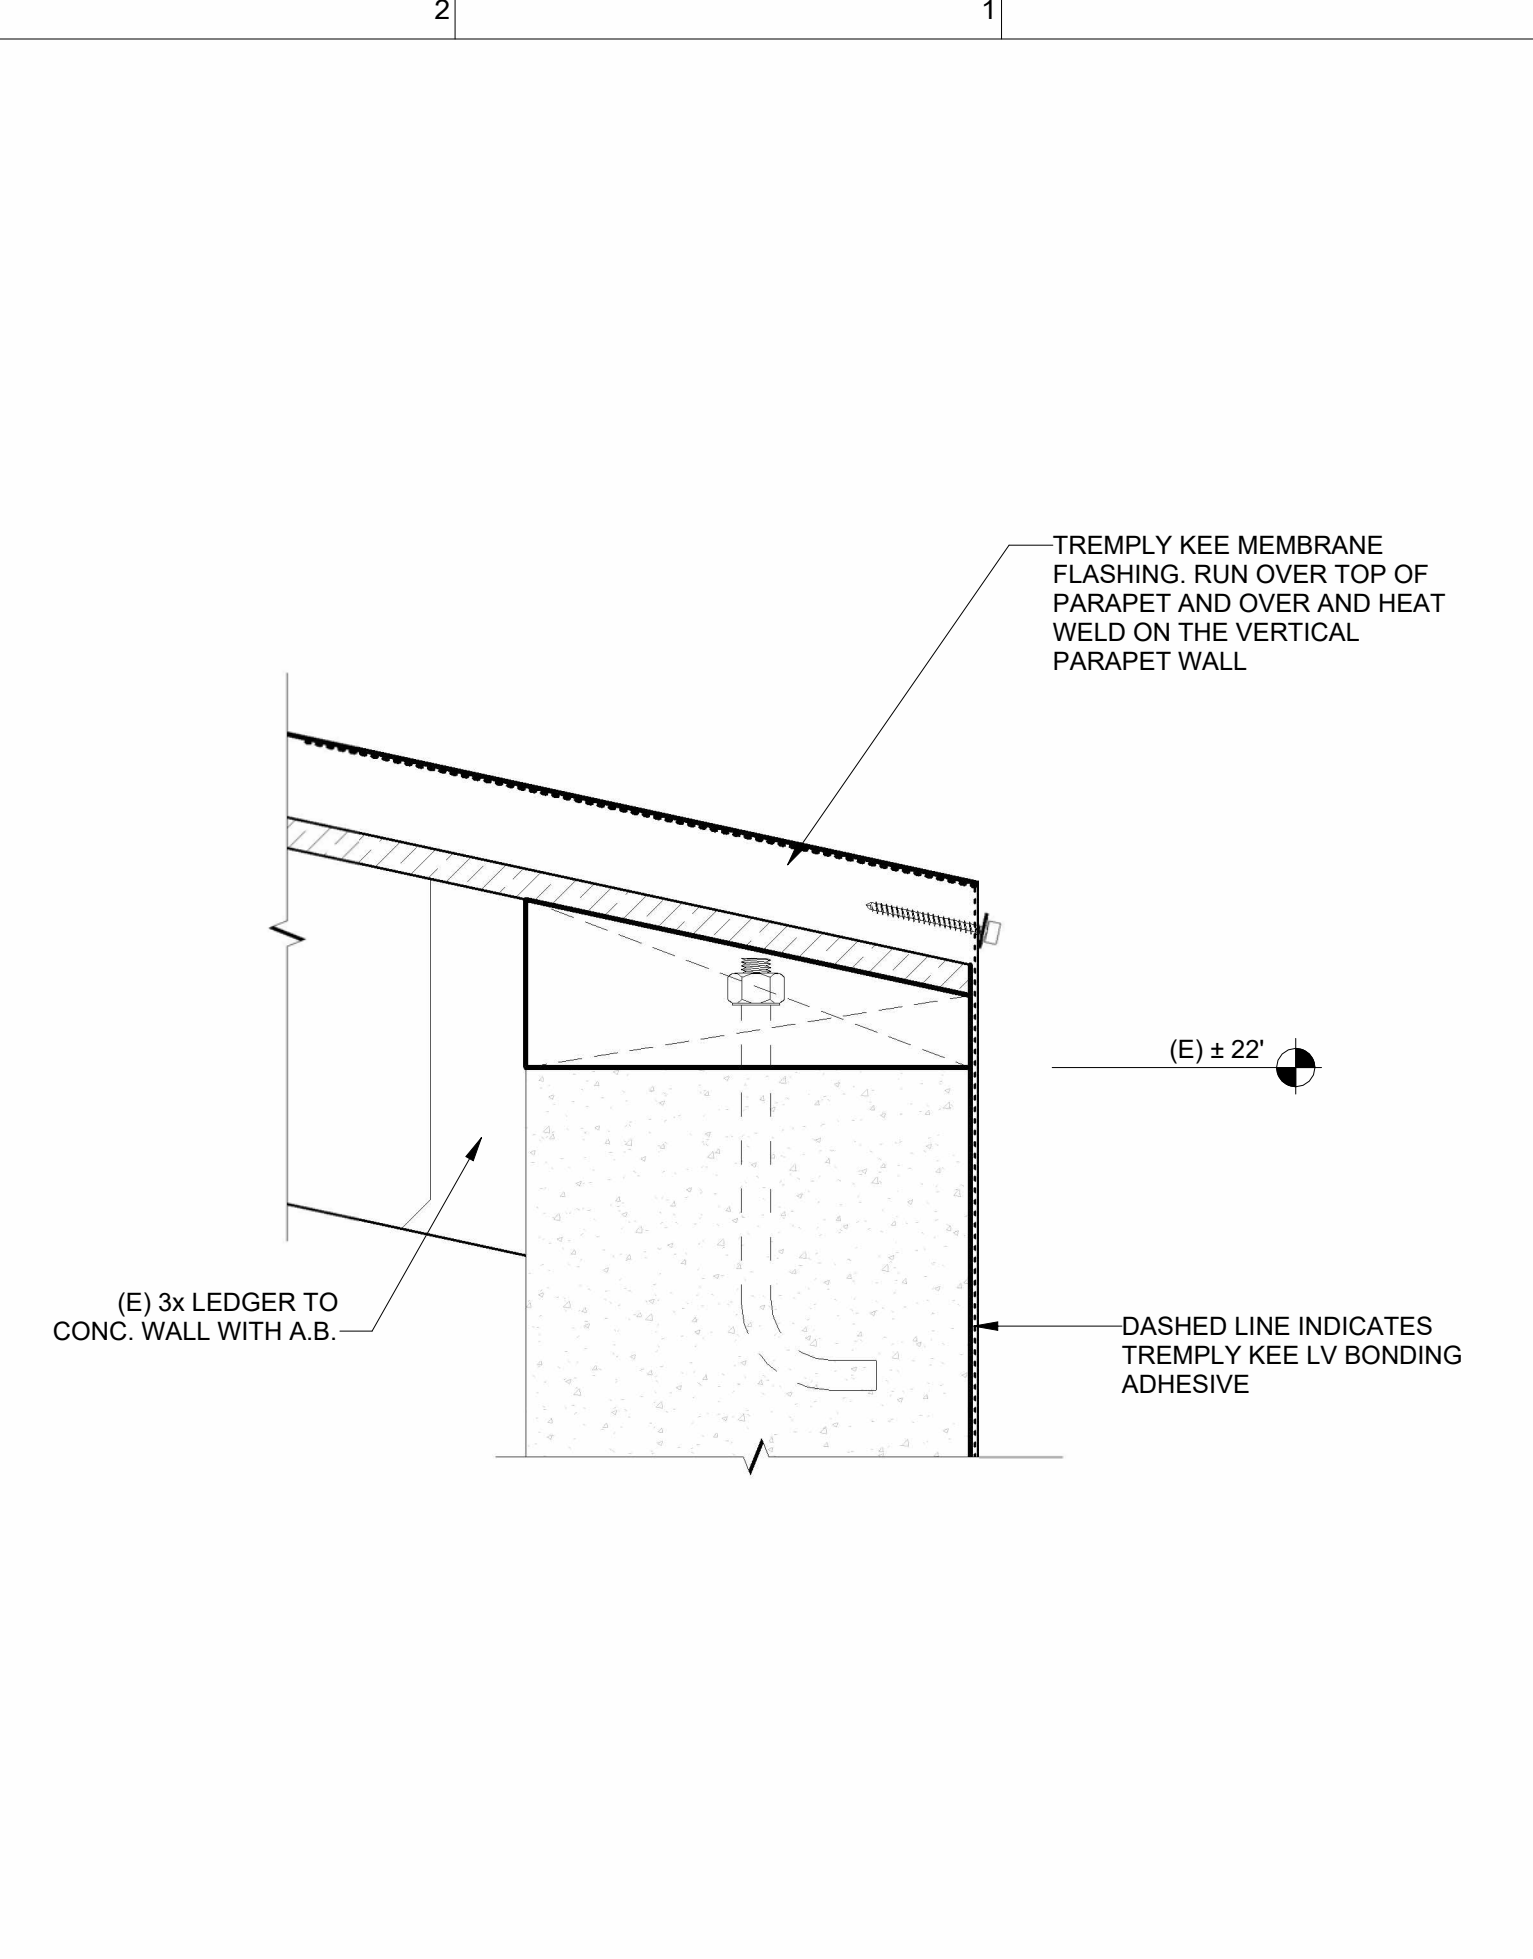


**OVER FLOW DRAIN D10**  
3" = 1'-0"

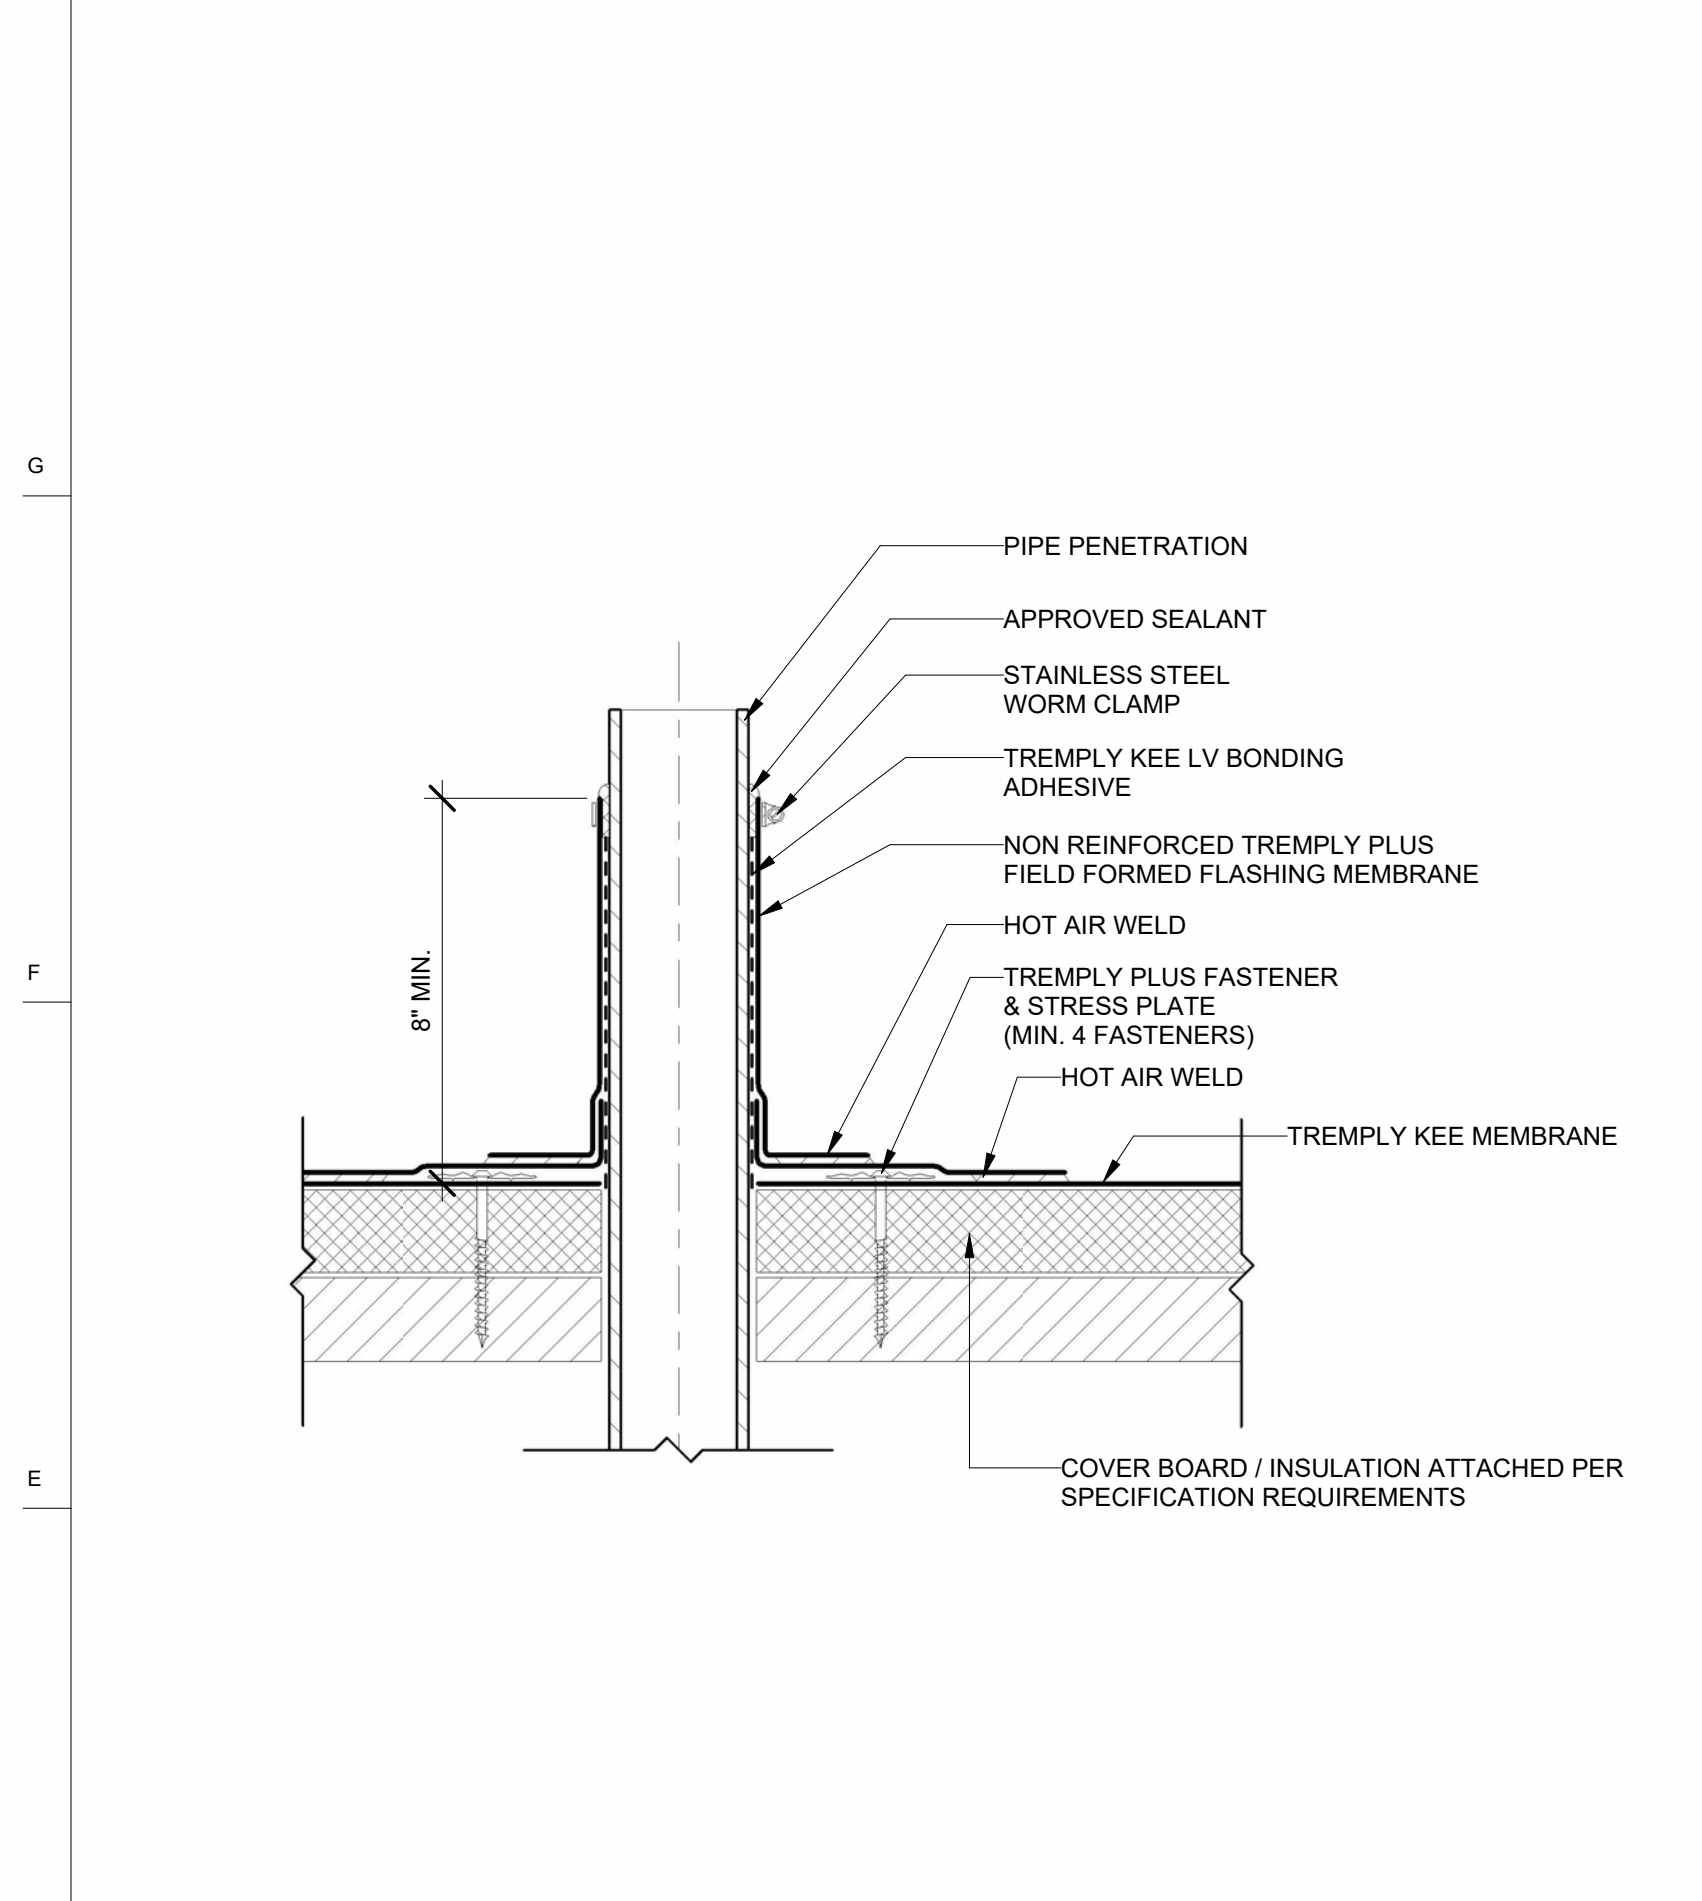


**BRICK VENEER / STUD WALL FLASHING D7**  
3" = 1'-0"

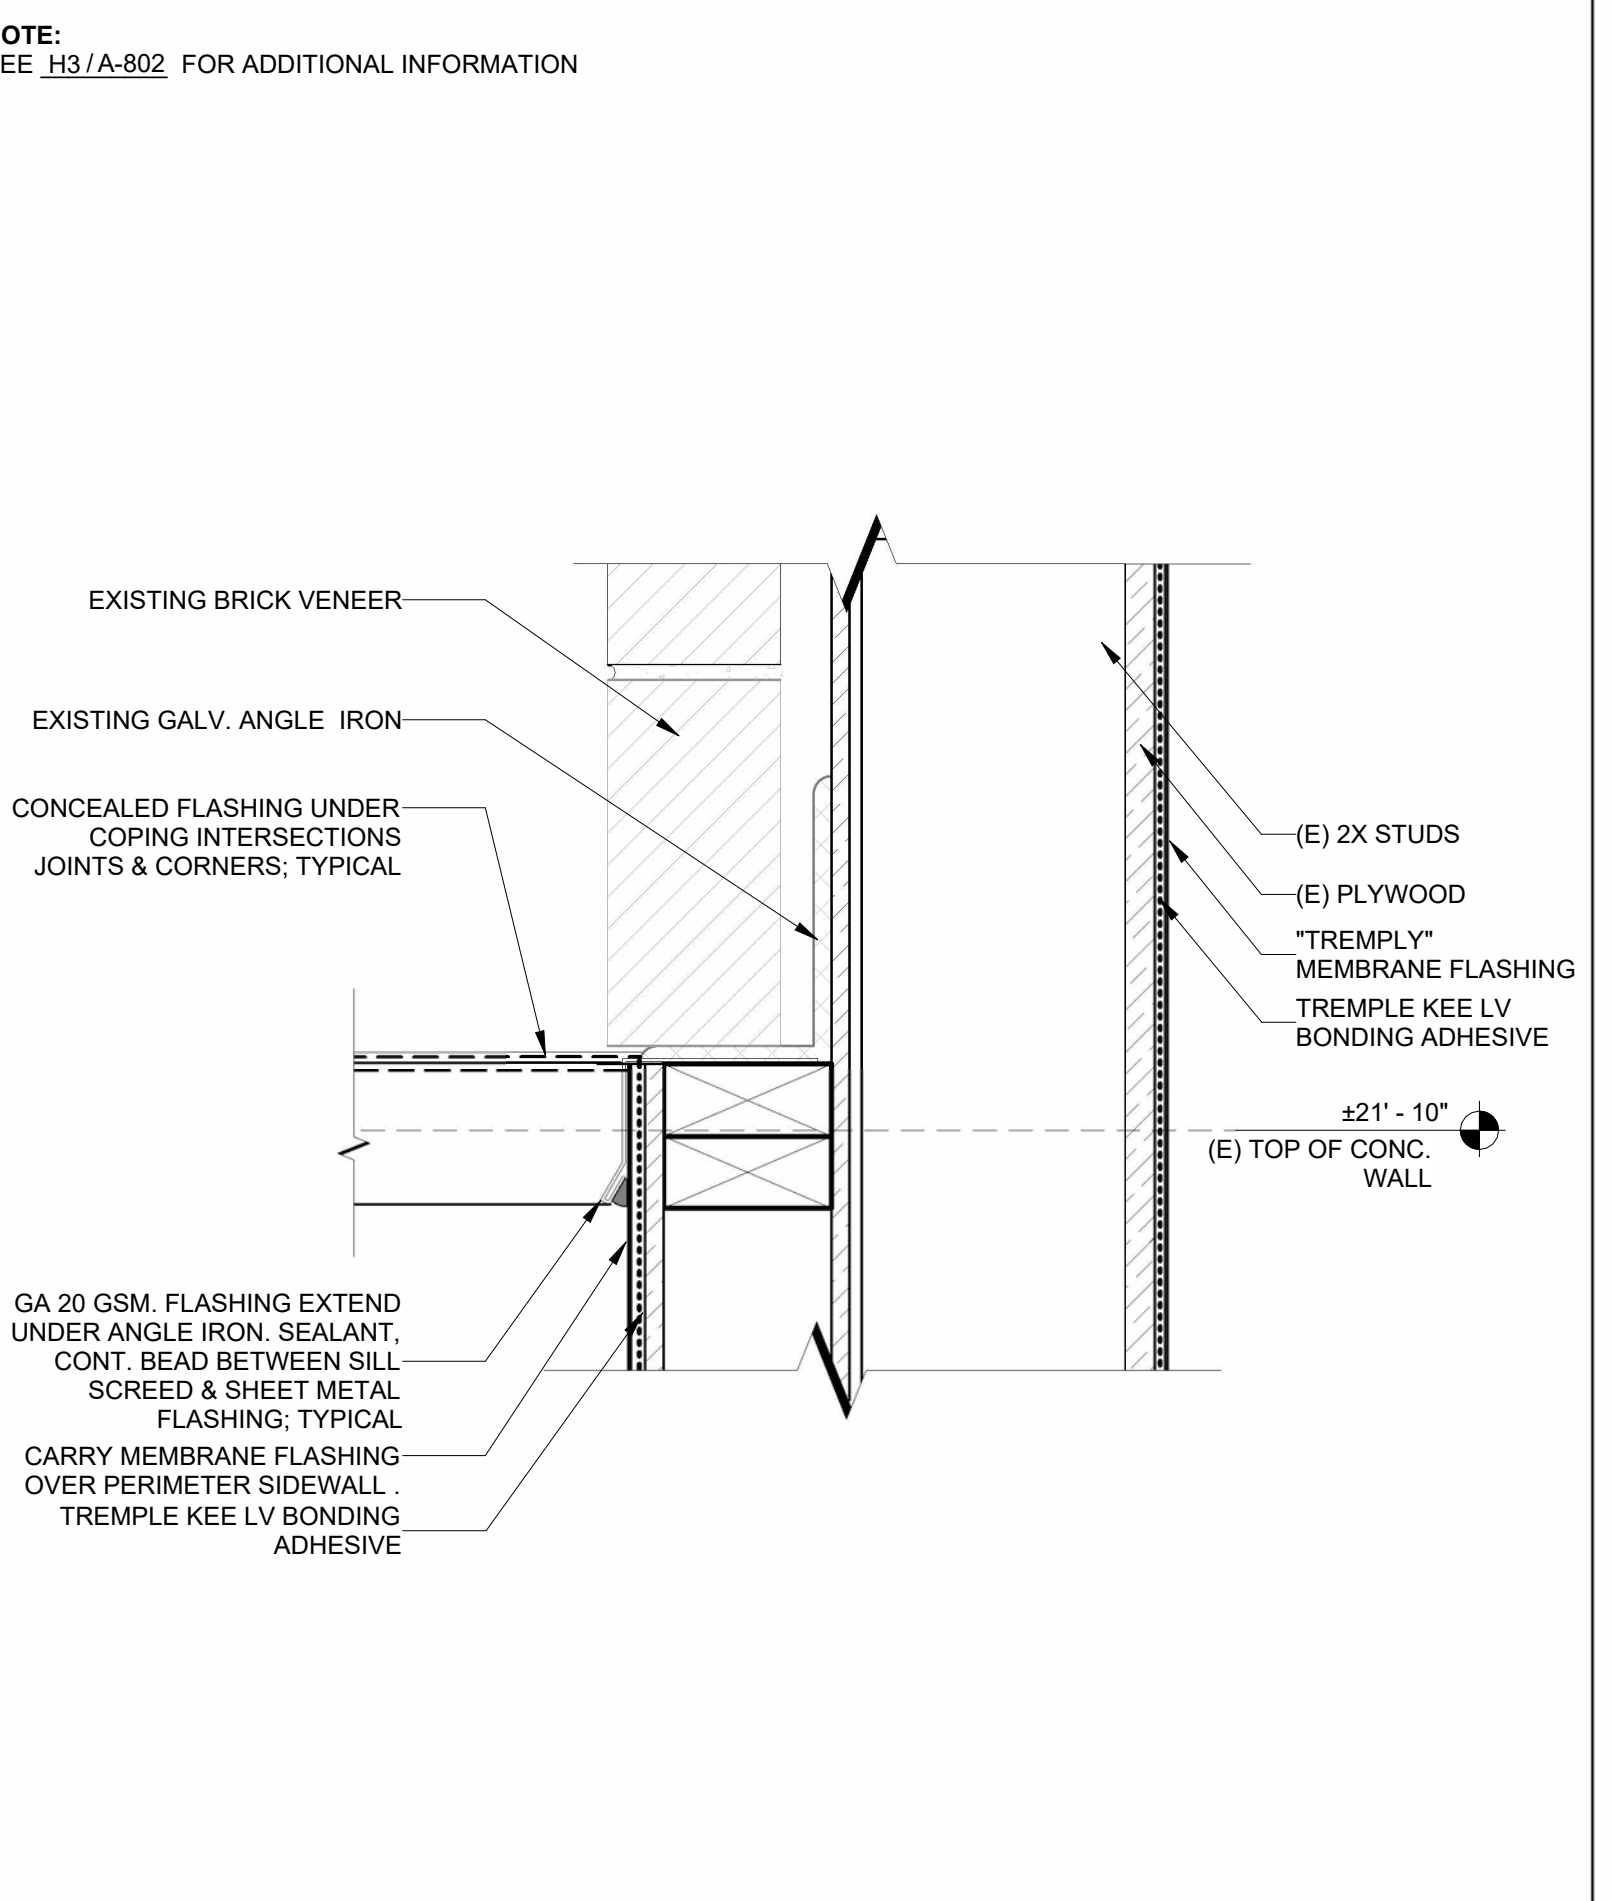


**ROOF HATCH D3**  
3" = 1'-0"

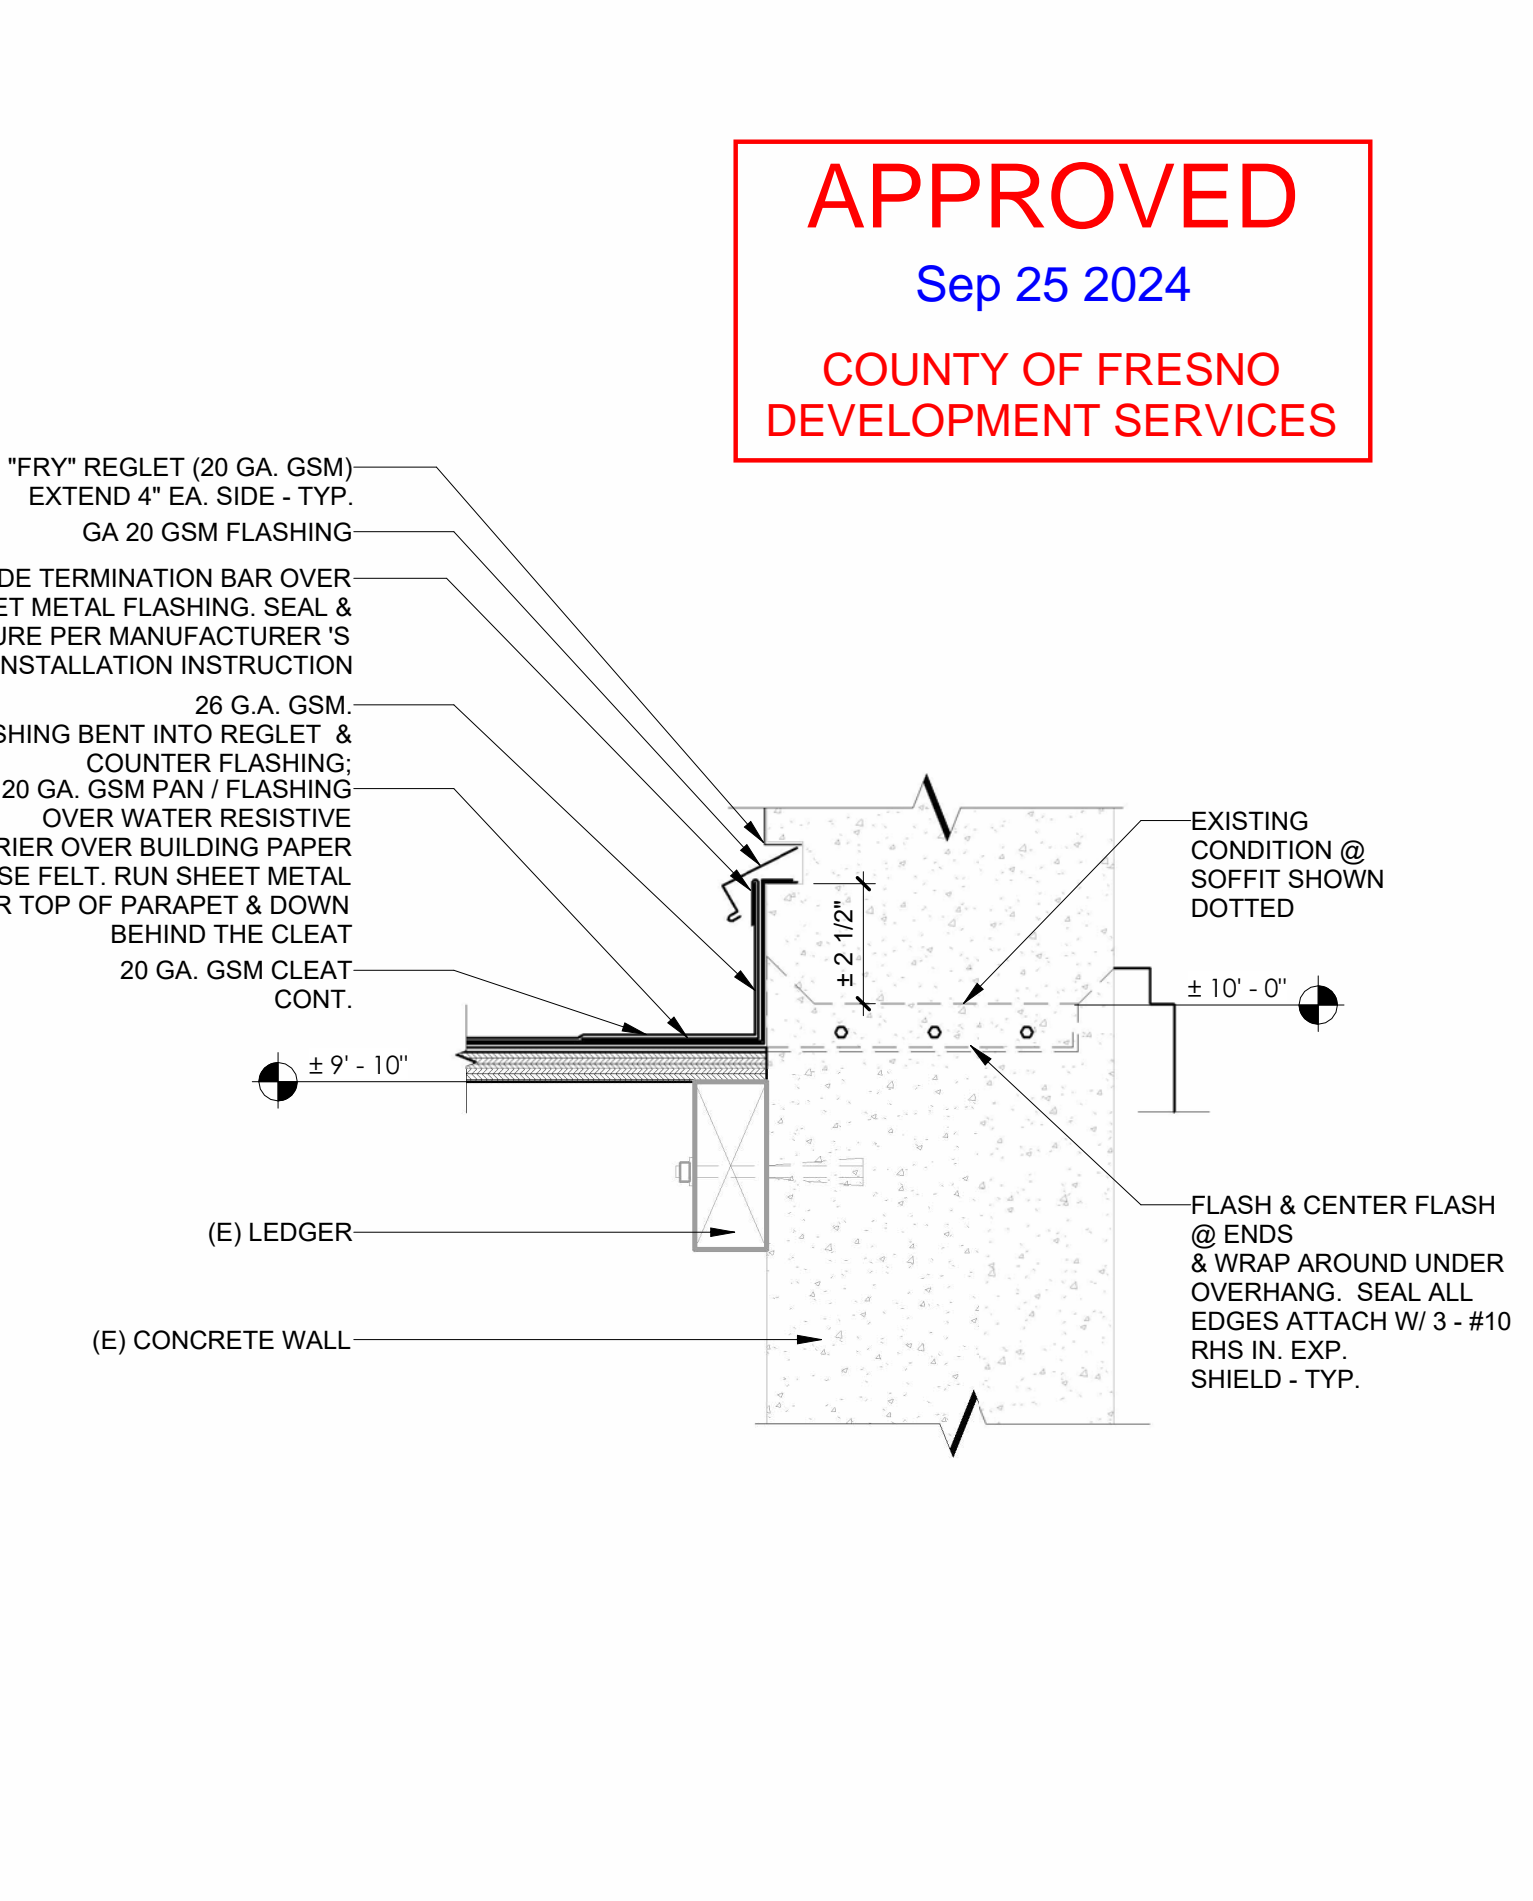


**WALL / ROOF FLASHING D1**  
3" = 1'-0"

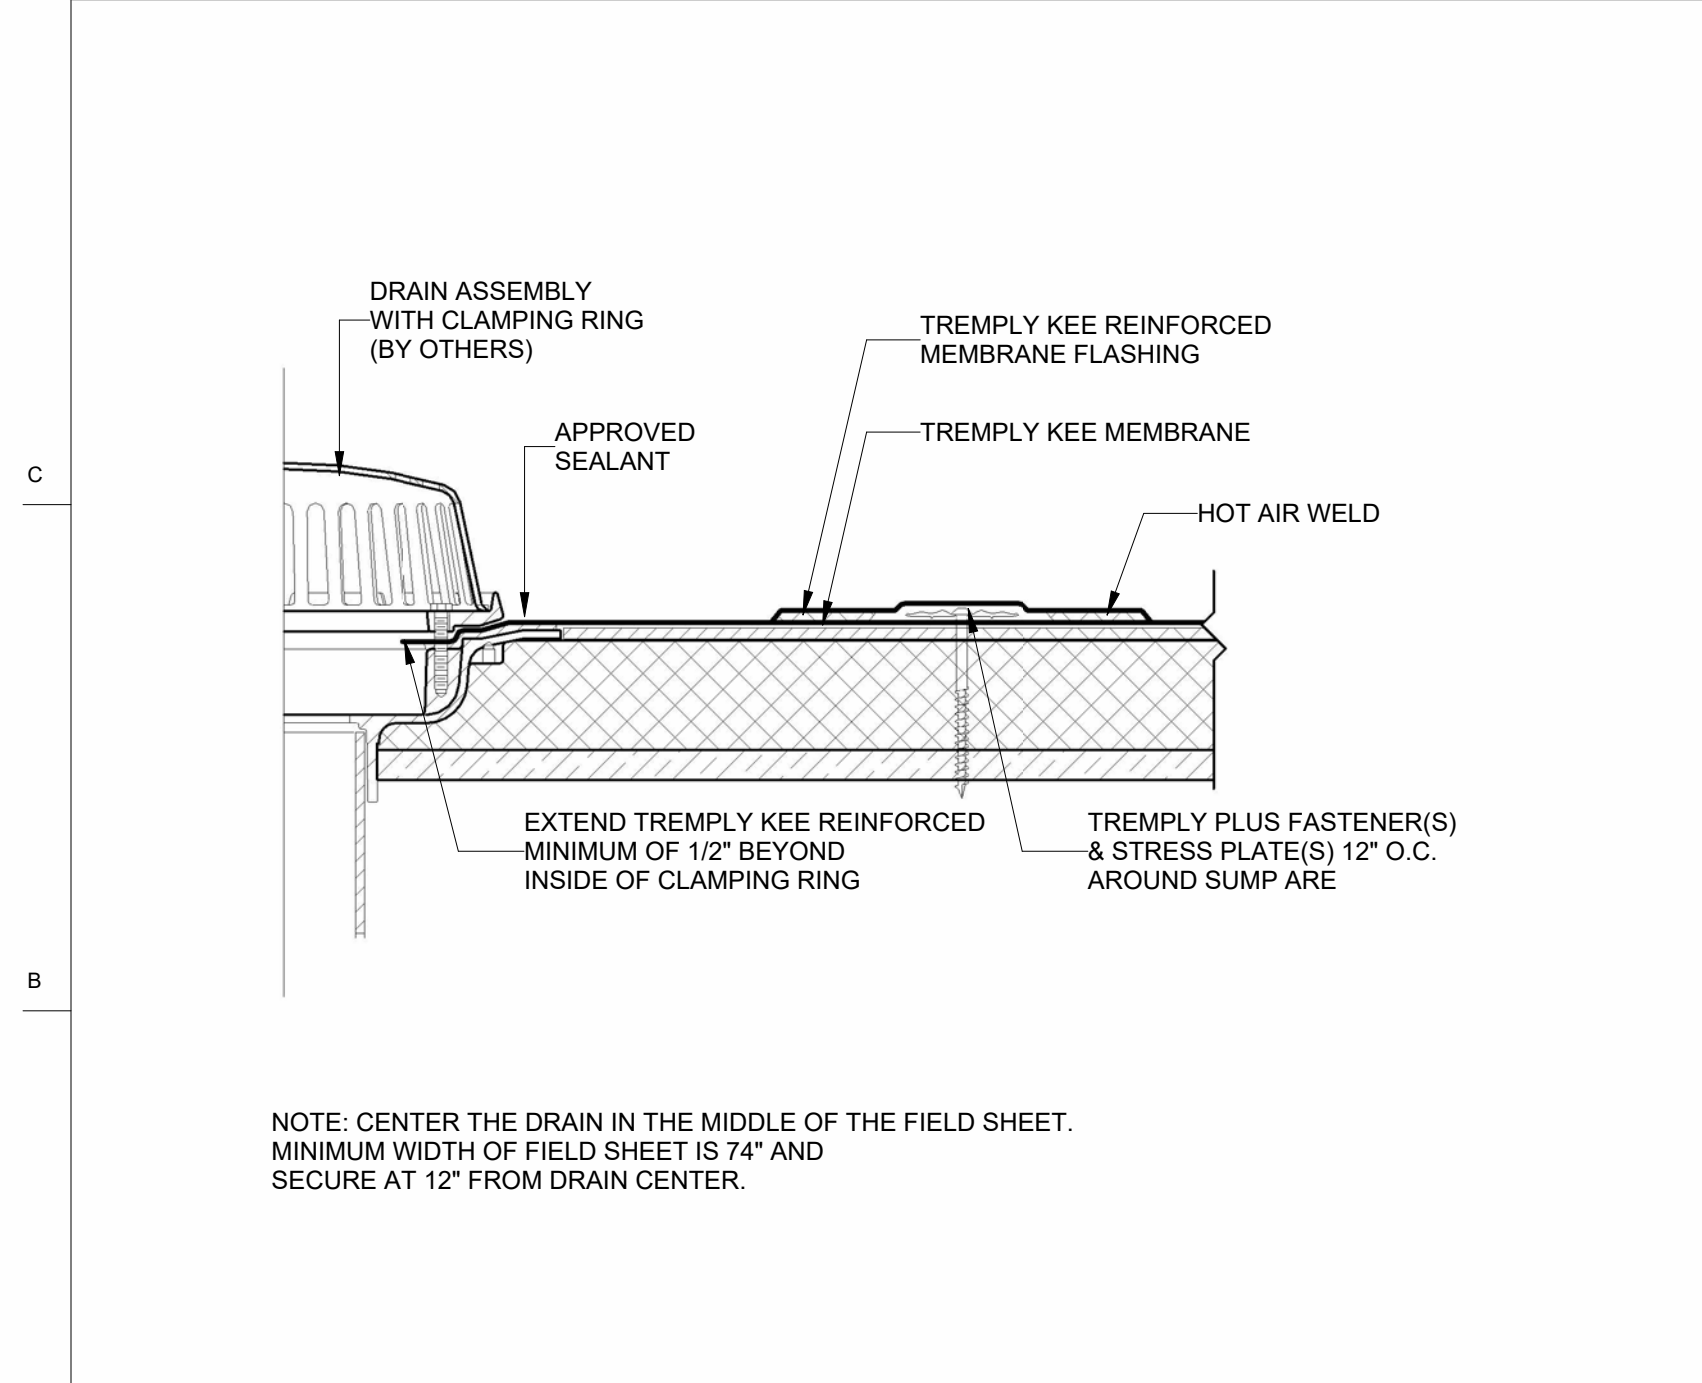


**ROOF DRAIN A10**  
3" = 1'-0"

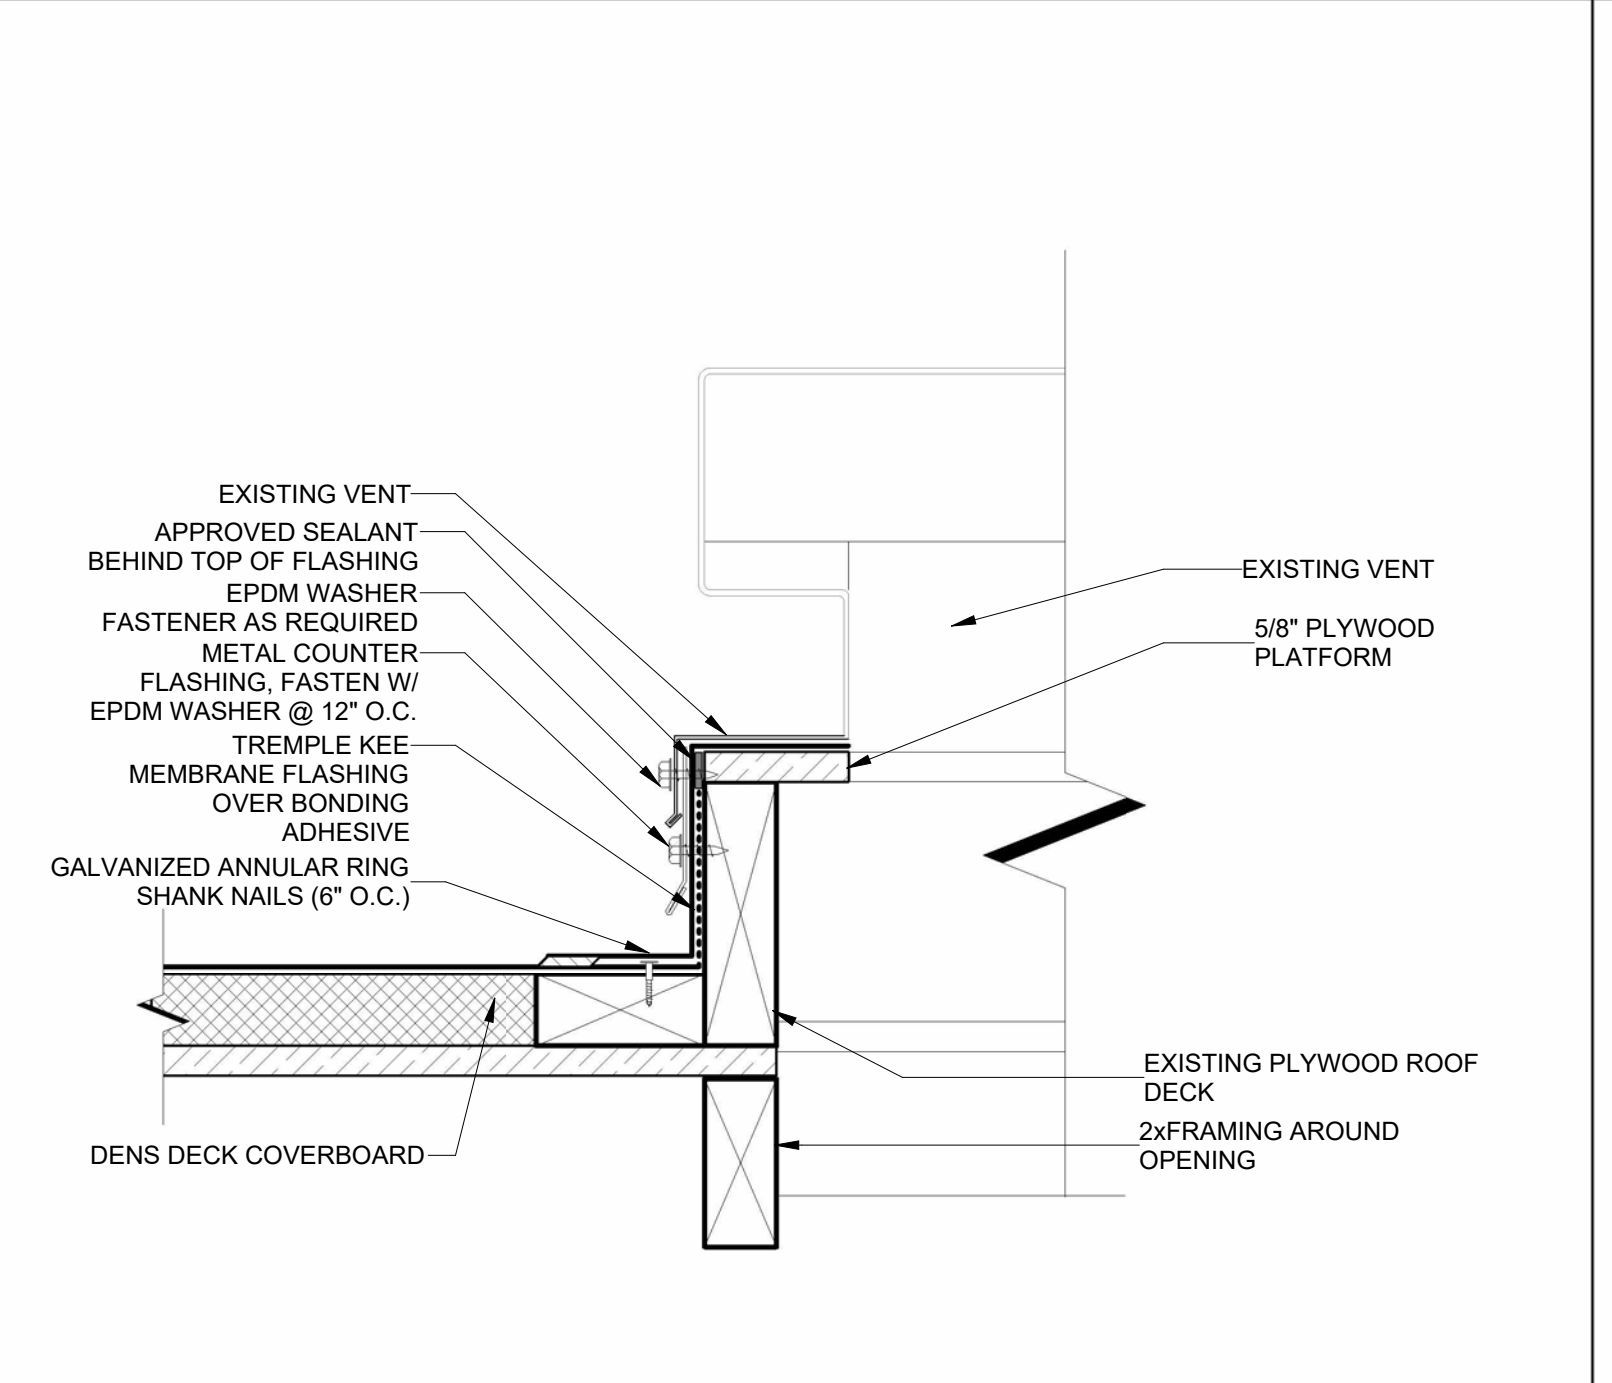

**SOFFIT VENTING FLASHING DETAIL A7**  
3" = 1'-0"

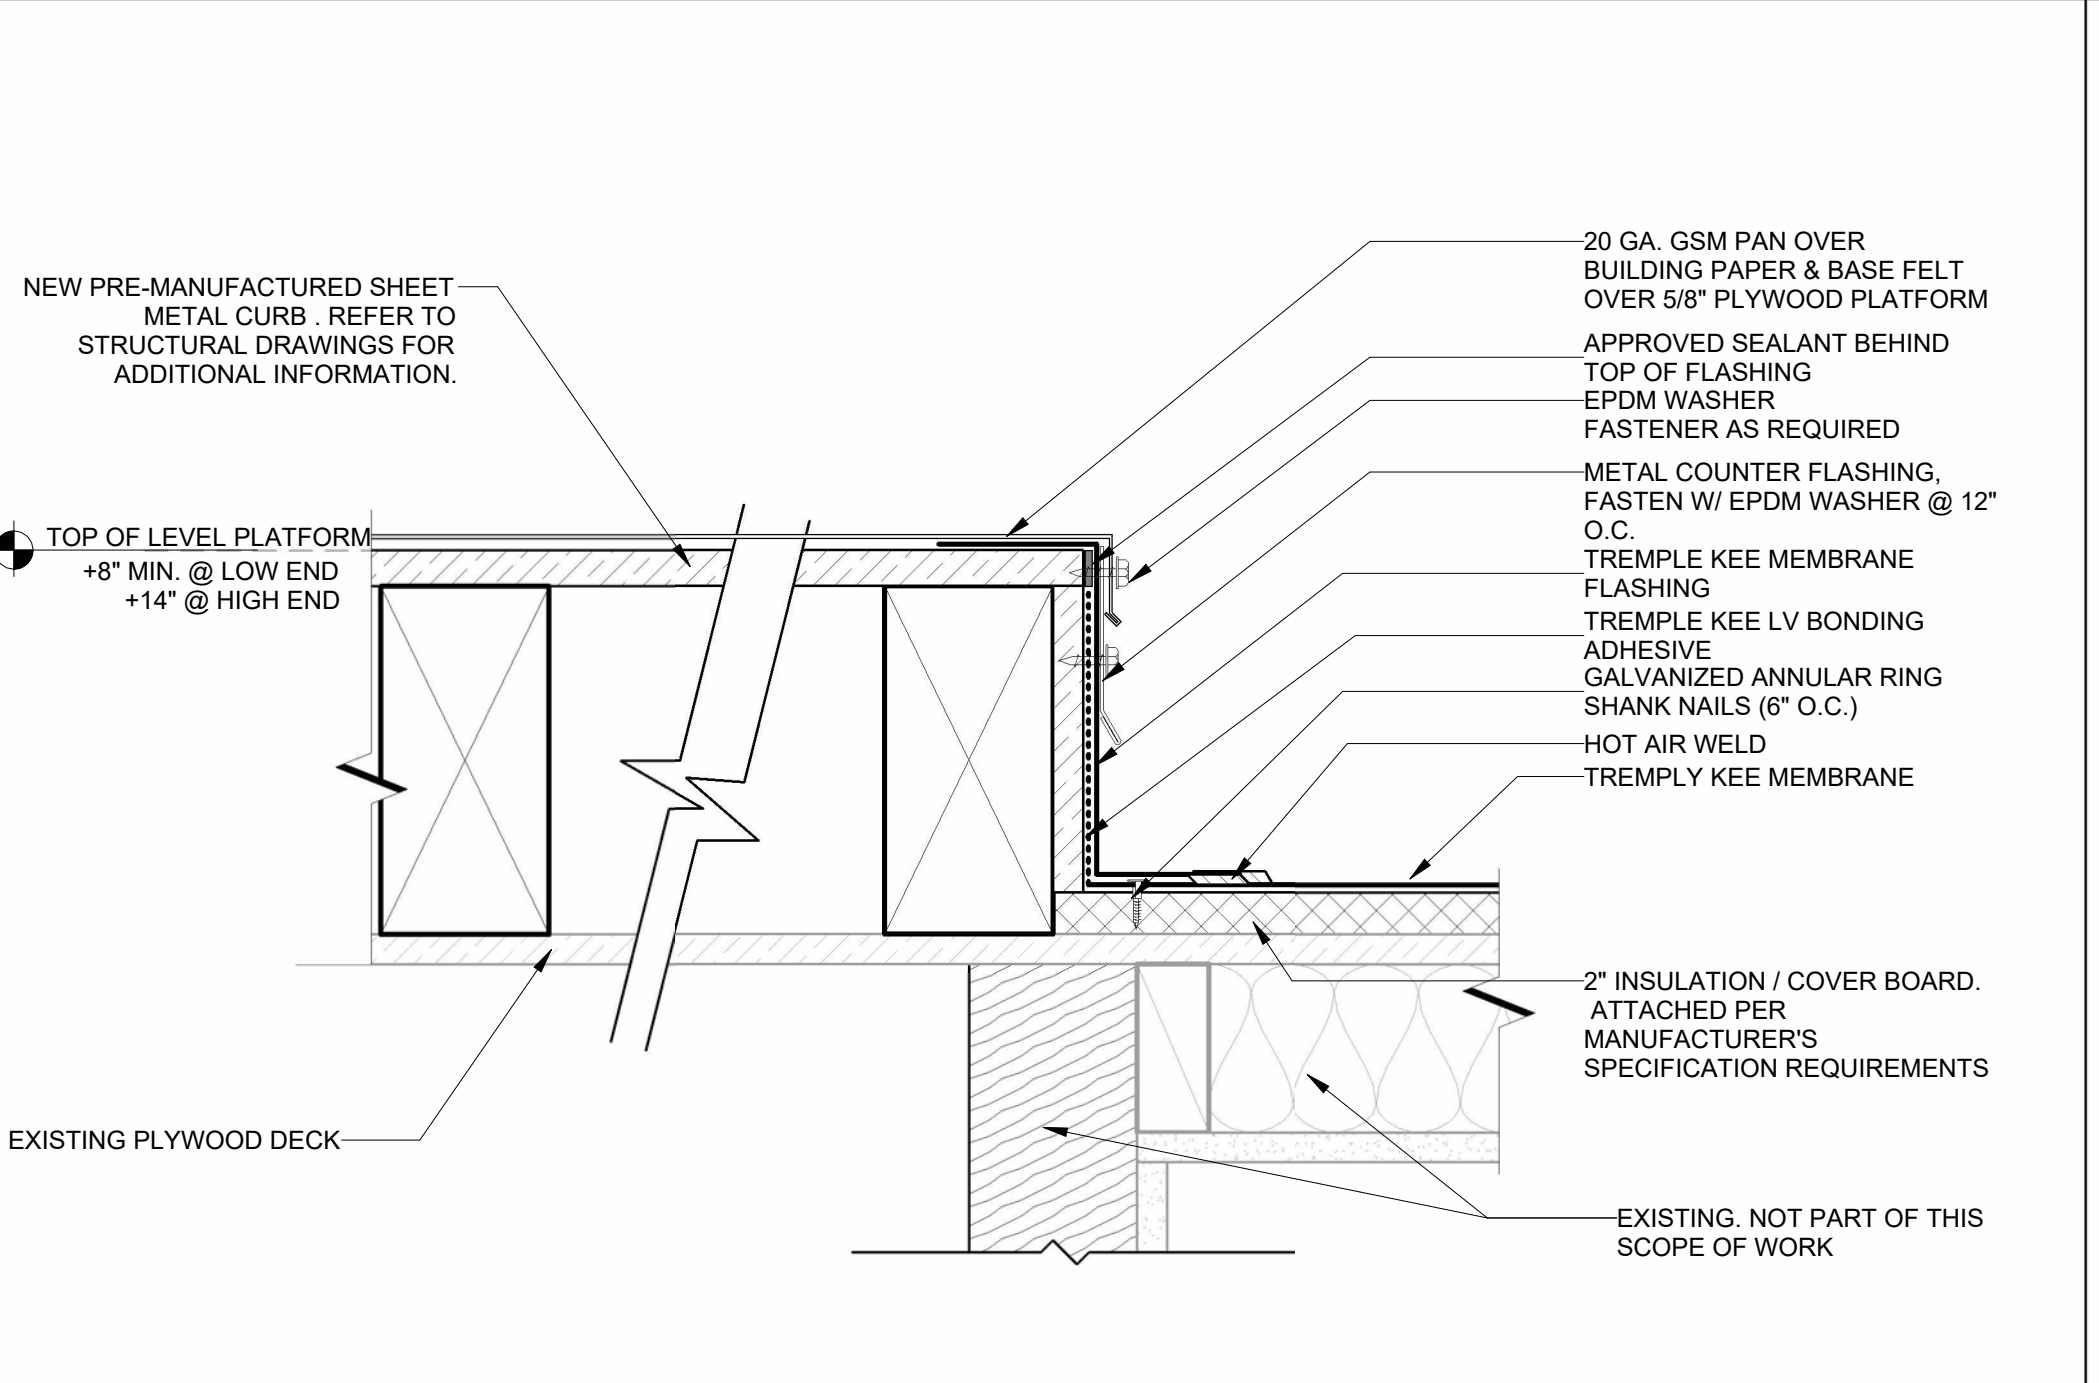

**MECHANICAL PLATFORM FLASHING DETAIL A3**  
3" = 1'-0"

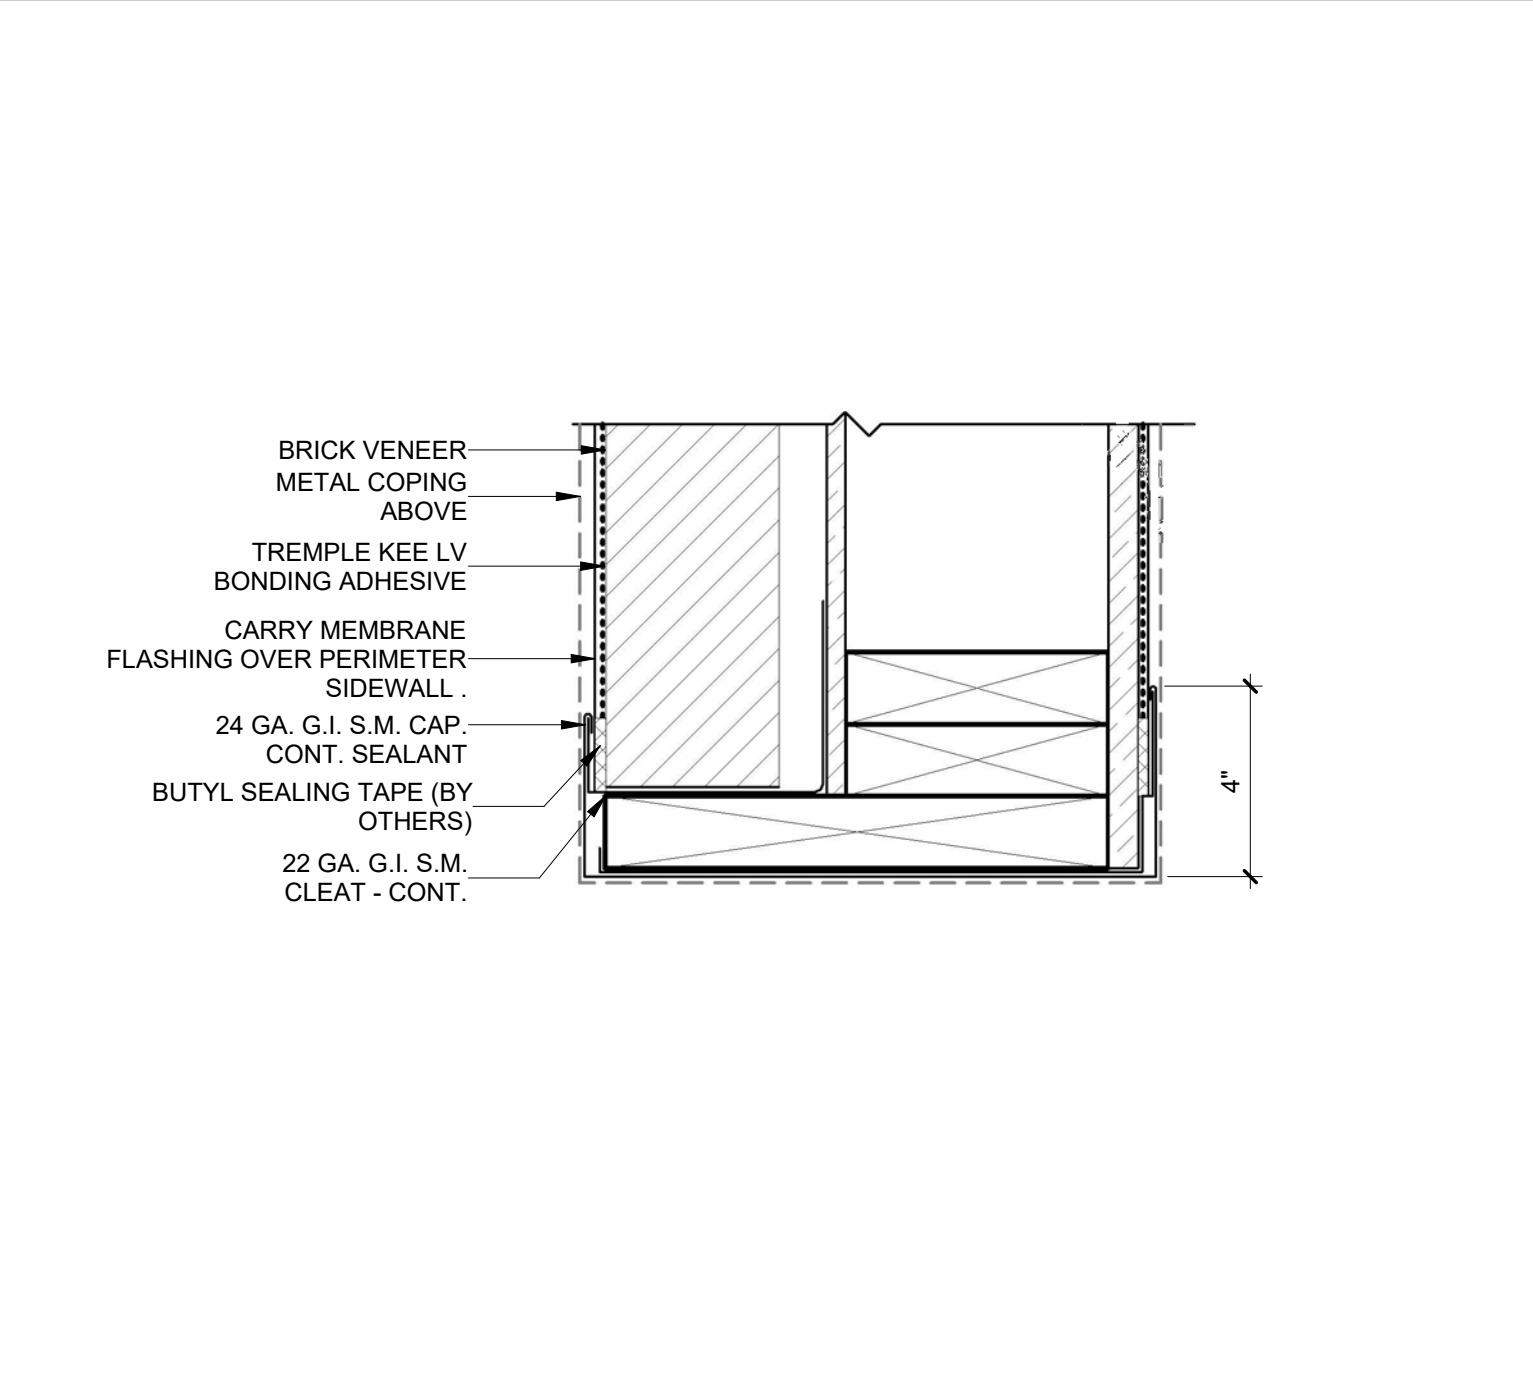

**METAL CAP AT WALL END A1**  
3" = 1'-0"

PROJECT  
**ROOF REPLACEMENT & FACADE REPAIRS**

5555 E Olive Avenue, Fresno, CA 93727

CLIENT  
**THE COUNTY OF FRESNO**

ARCHITECT  
**ROBINA WRIGHT Architect & Associates, Inc.**  
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SEAL & SIGNATURE  
**ROBINA WRIGHT ARCHITECT**  
ROBINA R. WRIGHT  
NO. C.S. 2283  
RENEWAL DATE: 06/30/2025  
CONSULTANT

UPDATE  
SEPTEMBER 18, 2024

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TITLE  
**ARCHITECTURAL DETAILS**

SCALE  
3" = 1'-0"  
PO #491344  
**A-802**

ISSUE DATE  
MAY 23, 2024  
JOB NUMBER  
2024\_10


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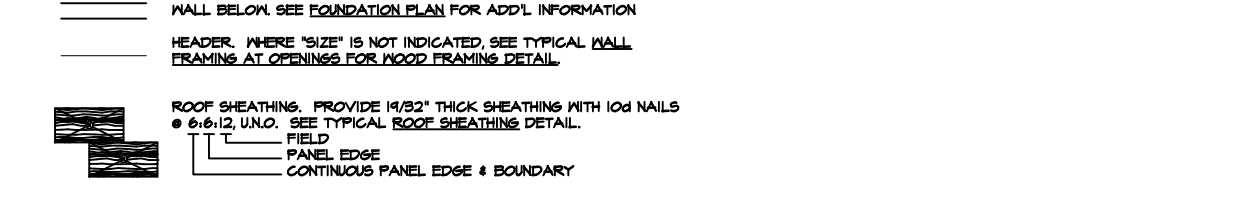





THE PACIFIC TELEPHONE AND TELEGRAPH CO.  
 5555 EAST OLIVE AVE.  
 FRESNO, CA




- ### ROOF FRAMING NOTES
- SEE TYPICAL SHEETS FOR ALL GENERAL AND MATERIAL NOTES AND ALL TYPICAL SCHEDULES AND DETAILS. THE INFORMATION ON THE TYPICAL SHEETS APPLY TO THE PROJECT AND ARE NOT SPECIFICALLY REFERENCED ON PLAN FORMS, UNLESS NOTED OTHERWISE. IF TYPICAL DETAILS ARE SPECIFIED ON PLANS OR NOTES, THEY WILL BE REFERENCED WITH THE WORD "TYPICAL," FOLLOWED BY BOLD AND UNDERLINED TEXT STATING THE TITLE OF THE DETAIL OR NOTE.
  - ALL ROOF MOUNTED HVAC UNITS TO BE INSTALLED IN THE FUTURE UNDER SEPARATE PERMITS.
  - ALL UNCLEAN AND/OR MISSING DETAILS SHALL BE BROUGHT TO THE STRUCTURAL ENGINEER'S ATTENTION BEFORE PROCEEDING WITH CONSTRUCTION.
  - ALL EXTERIOR WALLS AND EXTERIOR SOFFITS SHALL HAVE 5/8\"/>

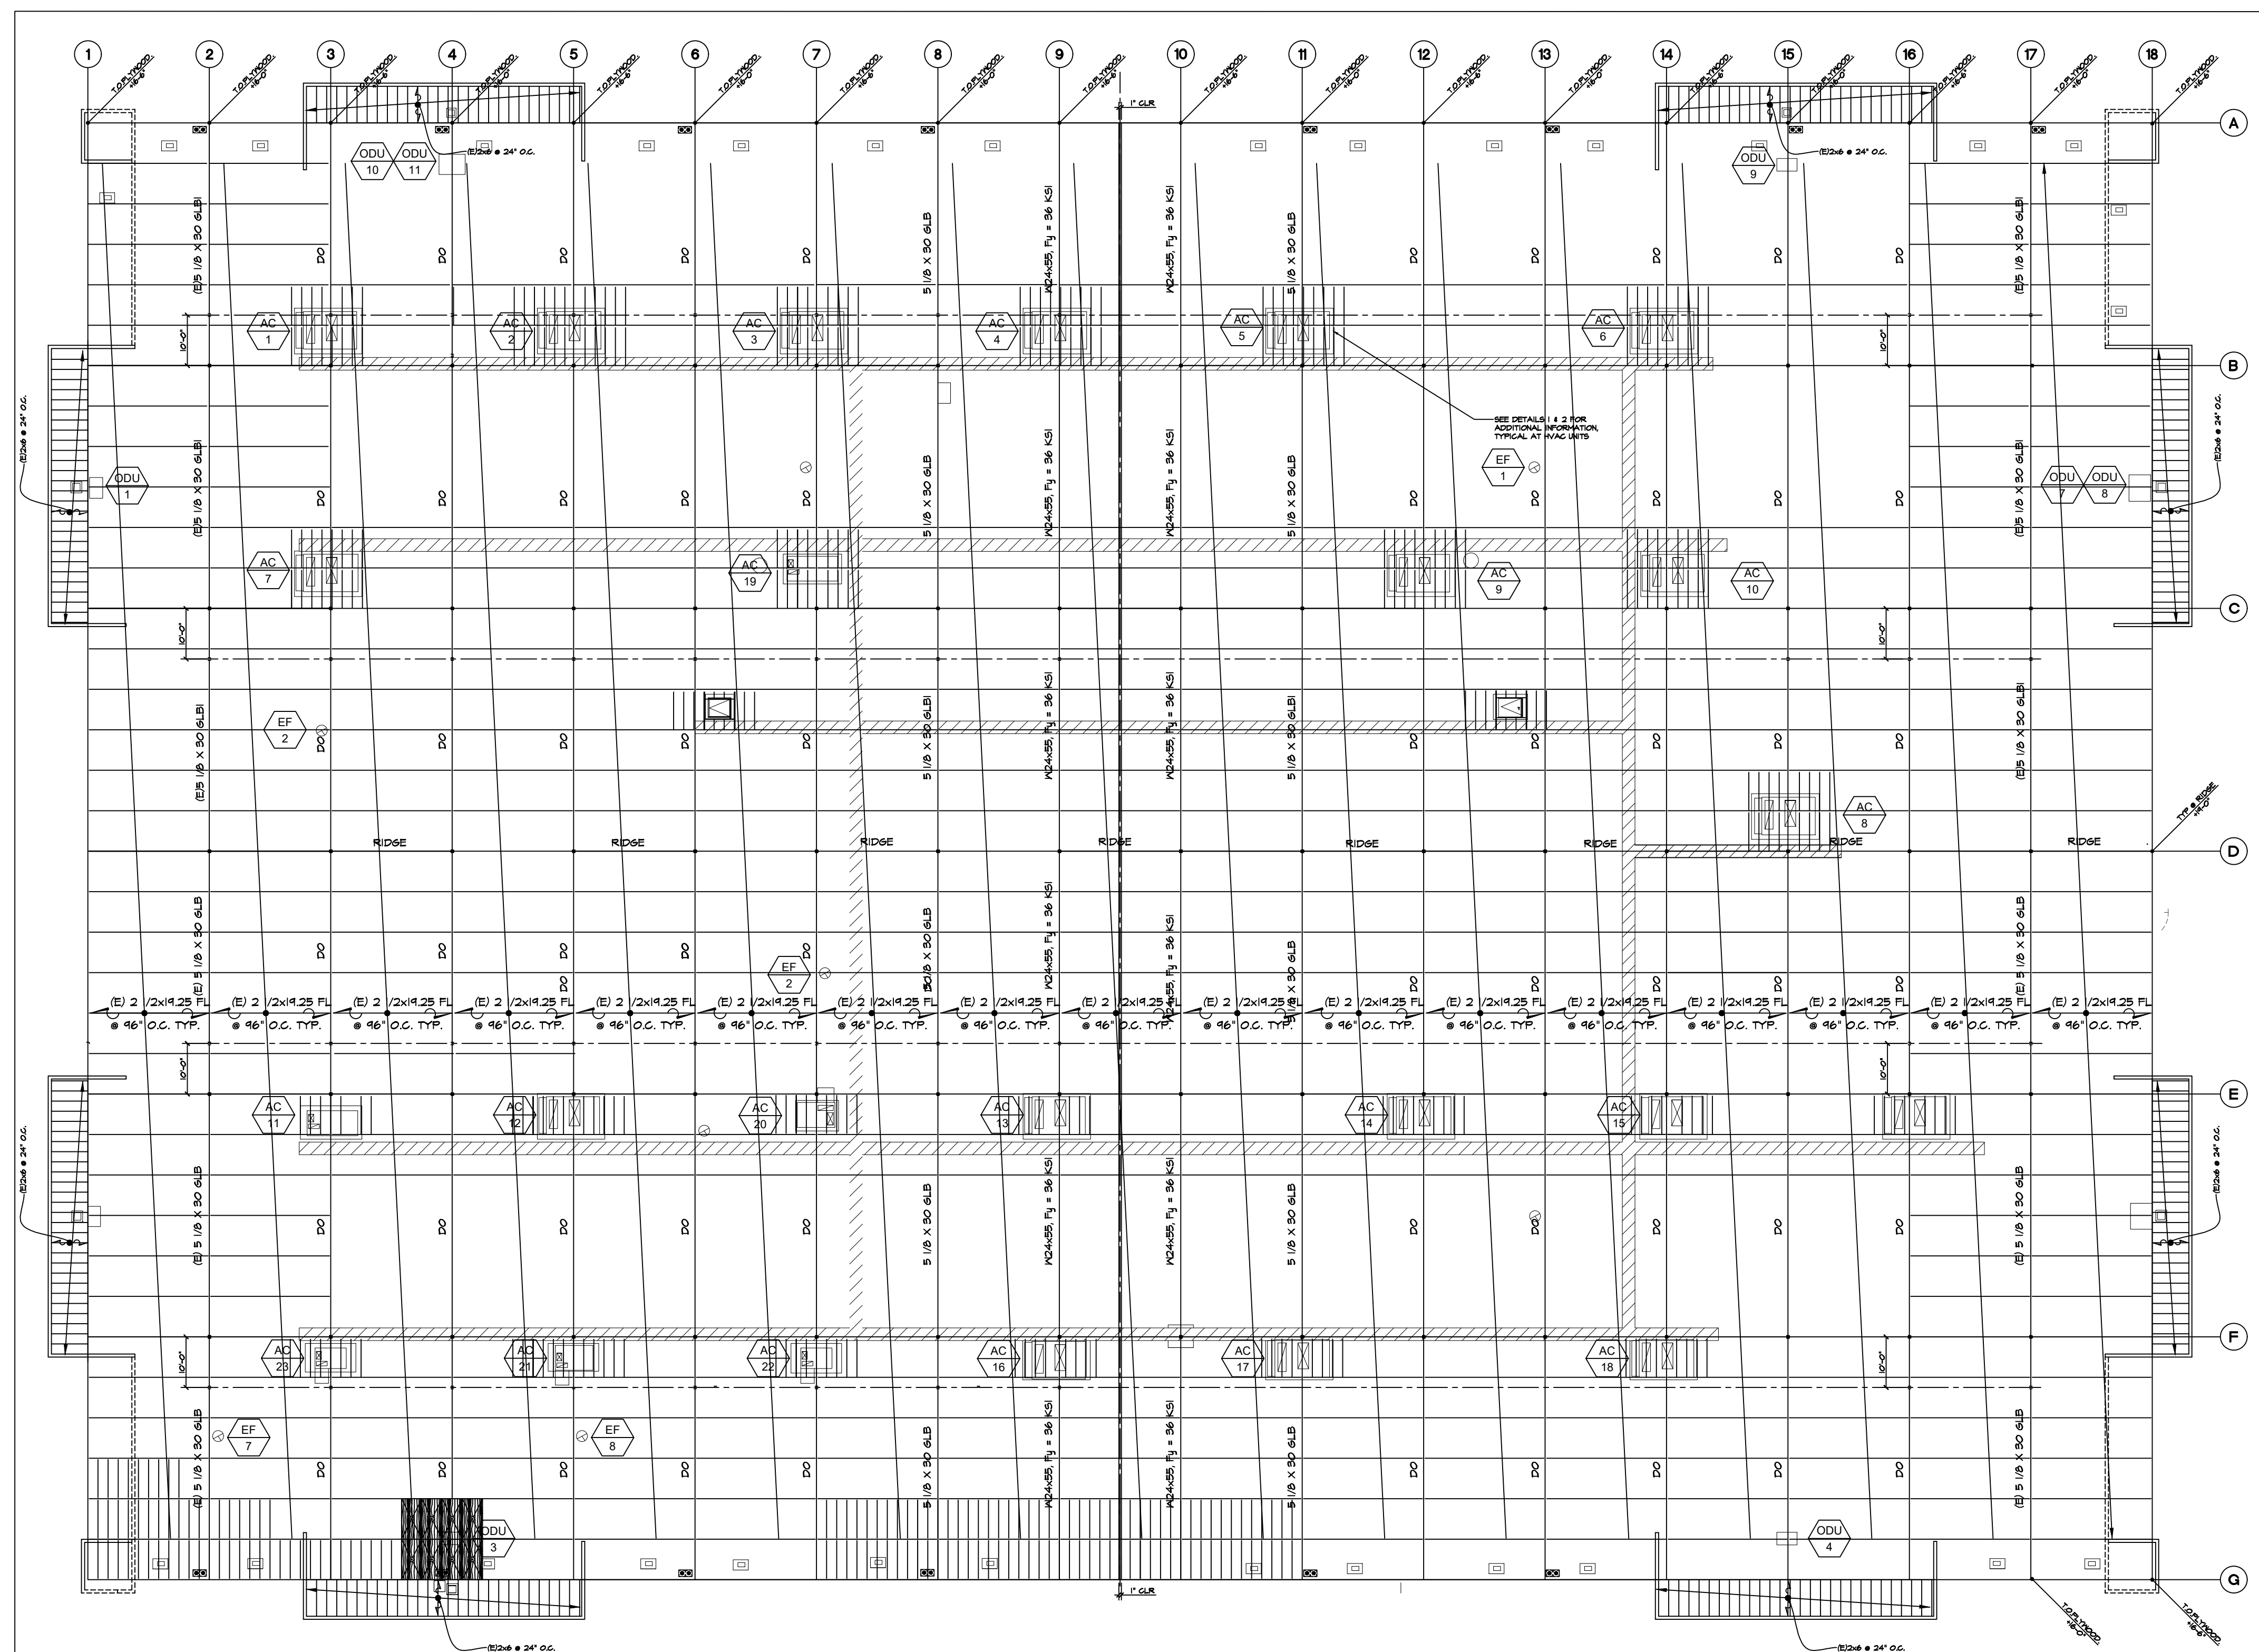


**APPROVED**  
 Sep 25 2024  
 COUNTY OF FRESNO  
 DEVELOPMENT SERVICES

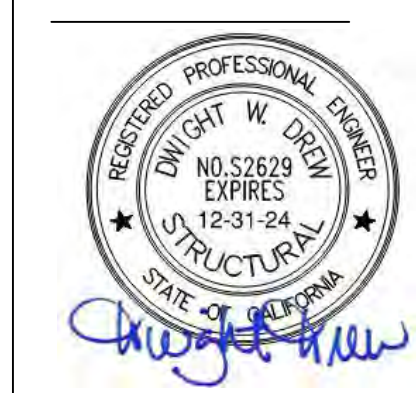


**ROOF FRAMING PLAN**  
 SCALE: 1/8\"/>

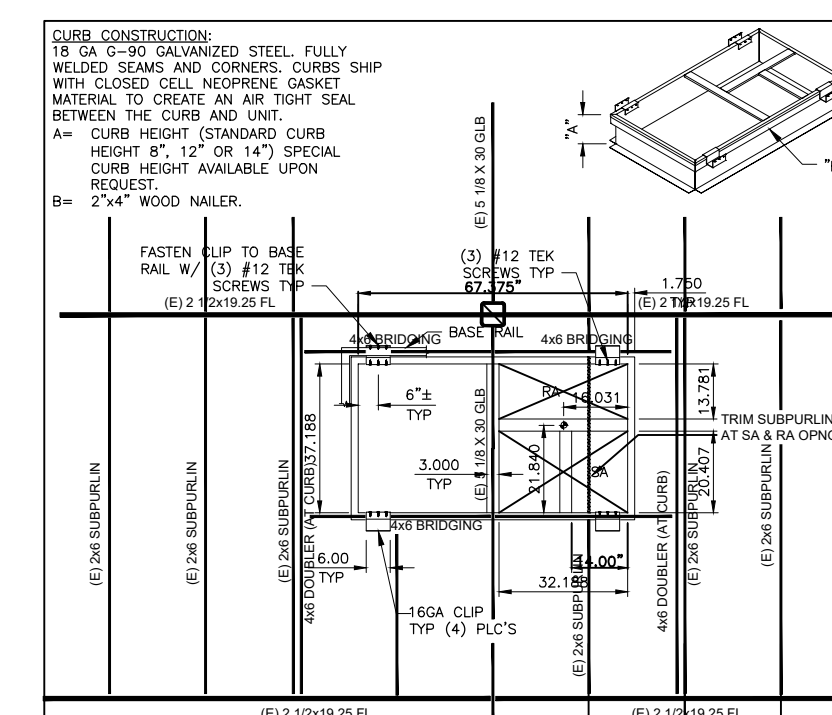


5 Pre-Manufactured Sheet Metal Curb  
 T&G 1402-B  
 SCALE: N.T.S.

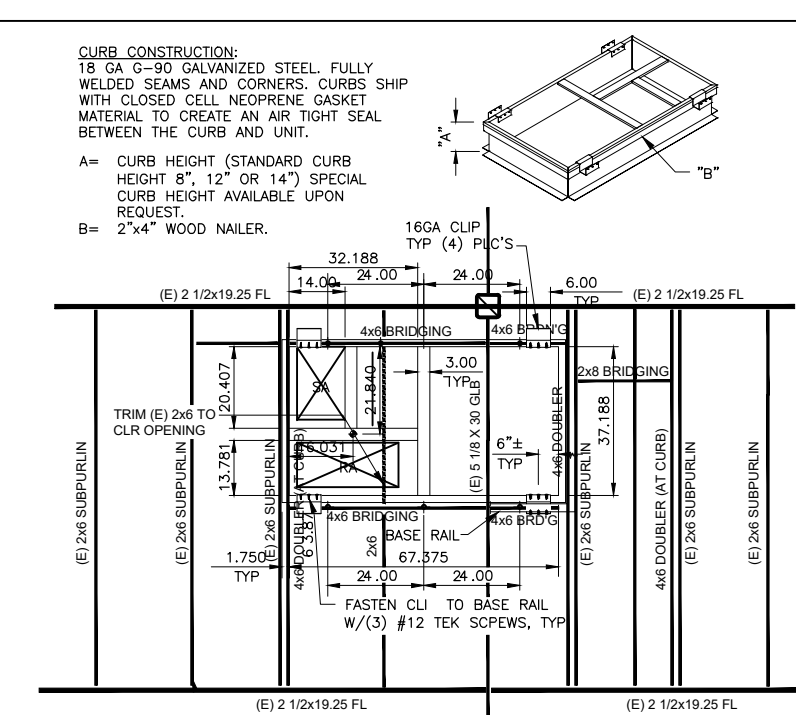


4 Pre-Manufactured Sheet Metal Curb  
 T&G 1402-B  
 SCALE: N.T.S.

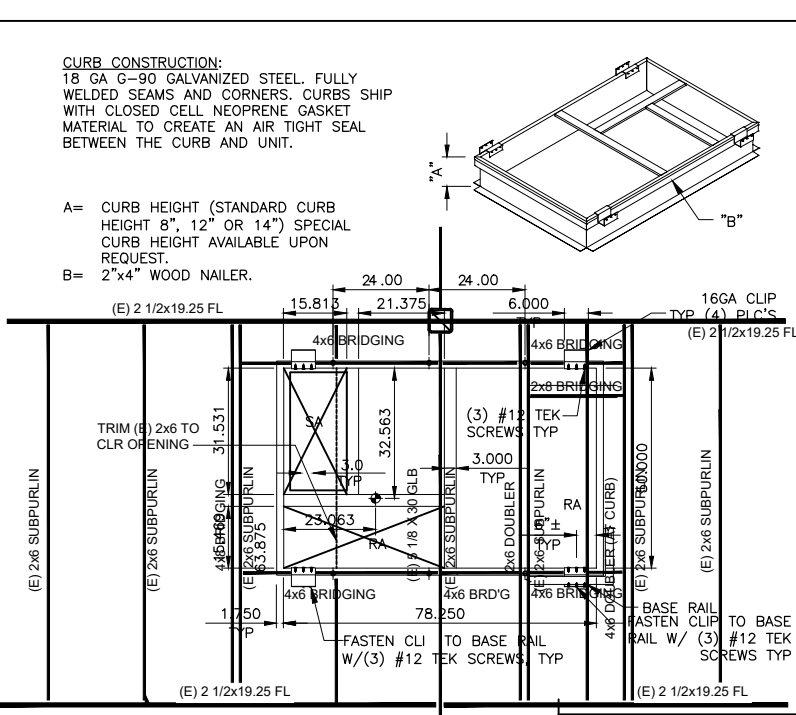

3 Pre-Manufactured Sheet Metal Curb  
 T&G 1402-B  
 SCALE: N.T.S.

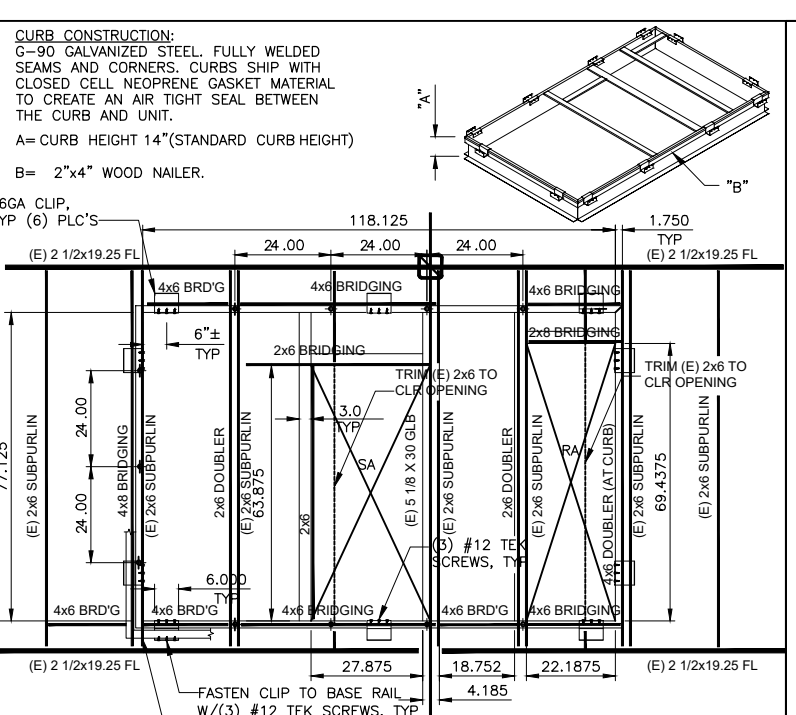

2 Pre-Manufactured Sheet Metal Curb  
 T&G 1402-B  
 SCALE: N.T.S.

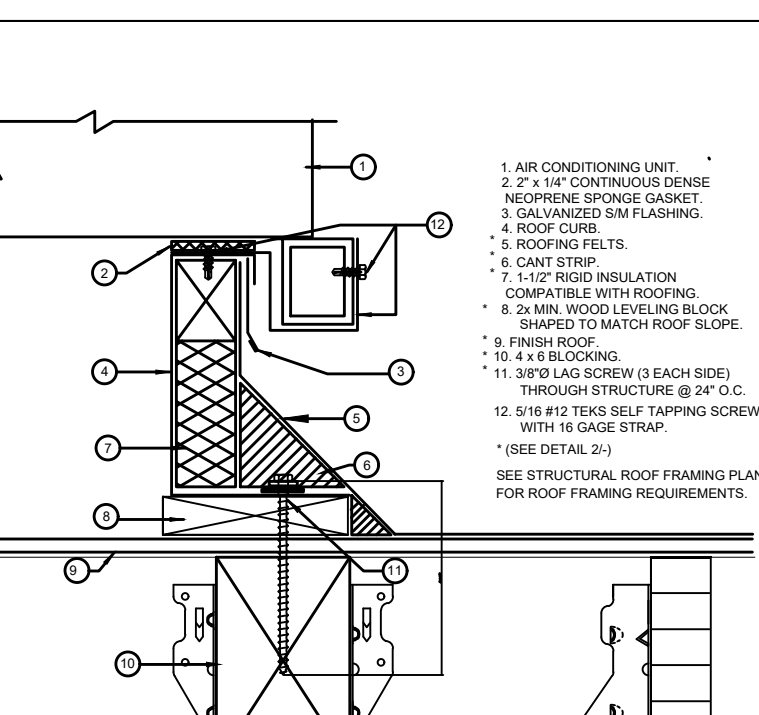

1 AC CURB MOUNTING DETAIL  
 SCALE: N.T.S.

STRUCTURAL ONE CORP  
 42380 BALD MOUNTAIN ROAD  
 AUBERRY, CA 93602  
 (559) 285-2727 DIRECT  
 dwight@structuralonecorp.com

PROJECT NUMBER  
 24023

SHEET NUMBER


S202

AIR CONDITIONING LEGEND					
SYMBOL	ITEM	ABBR	SYMBOL	ITEM	ABBR
	ROUND DUCT	Ø		HOT WATER SUPPLY	HWS
	FLAT OVAL DUCT	⊖		HOT WATER RETURN	HWR
	SHEET METAL DUCT	—		CHILLED WATER SUPPLY	CWS
	ACOUSTIC LINING FOR DUCT OR GRILLES	(L)		CHILLED WATER RETURN	CWR
	DUCT W/EXIT INSULATION & GALV. SM SUNSHIELD	—		CHILLED/HOT WATER SUPPLY	CHWS
	DUCT W/EXIT INSULATION & GALV. SM SUNSHIELD	—		CHILLED/HOT WATER RETURN	CHWR
	SUPPLY AIR DUCT DROP	—		STEAM SUPPLY (X IS PSI)	S-X
	RETURN AIR DUCT DROP	—		STEAM CONDENS. RETURN	SCR
	EXHAUST DUCT AIR DROP	—		DRAIN	D
	SUPPLY AIR DUCT RISE	—		CONDENSATE DRAIN	CD
	RETURN AIR DUCT RISE	—		BALL VALVE	—
	EXHAUST AIR DUCT RISE	—		BUTTERFLY VALVE	—
	TURNING VANES	TV		CHECK VALVE	—
	EXTRACTOR	—		GATE VALVE	—
	VOLUME CONTROL DAMPER W/LOCKING QUADRANT	VCD		SHUT-OFF VALVE	SOV
	OPPOSED BLADE DAMPER	OBD		PLUG VALVE	—
	BACKDRAFT DAMPER	BDD		PRESSURE RELIEF VALVE	PRV
	VOLUME CONTROL DAMPER W/REMOTE REGULATOR	VCR		UNION	—
	FIRE/SMOKE DAMPER WITH ACCESS PANEL	F/SD		INSTRUMENT WELL	—
	FIRE DAMPER WITH ACCESS PANEL	FD		FLOW SWITCH	FS
	SMOKE DAMPER WITH ACCESS PANEL	SD		STRAINER	—
	CUBIC FEET OF AIR PER MINUTE	CFM		FLEXIBLE CONNECTION	FLEX
	THERMOSTAT @ +4'-0" TOP OF BOX	T'STAT		REDUCER OR INCREASER	—
	HUMIDISTAT @ +4'-0" TOP OF BOX	H'STAT		POINT OF CONNECTION EXISTING (DESIGNATED)	(E)
	CO2 SENSOR @ +4'-0" TOP OF BOX	CO2		PIPE/DUCT TURN DOWN	—
	EMS TEMPERATURE SENSOR @ +4'-0" TOP OF BOX	—		PIPE/DUCT TURN UP	—
	EMS HUMIDITY SENSOR @ +4'-0" TOP OF BOX	—		DIRECTION OF FLOW	—
	EMS CO2 SENSOR @ +4'-0" TOP OF BOX	CO2		NEW (DESIGNATED)	(N)
	SUPPLY AIR	SA		ABOVE GRADE	AG
	RETURN AIR	RA		BELOW GRADE	BG
	EXHAUST AIR	EA		CONDENSER WATER RETURN	CS
	AUDIBLE/VISUAL ALARM	A/VA		CONDENSER WATER SUPPLY	CR
	BYPASS TIMER	BPT		REFRIGERANT DISCHARGE	RD
				REFRIGERANT LIQUID	RL
				REFRIGERANT SUCTION	RS
				ENERGY MANAGEMENT SYSTEM CABLE IN CONDUIT	EMS
				EMS STATIC PRESSURE SENSOR	SP
				EMS DIFFERENTIAL PRESSURE SENSOR	DP
				EMS CURRENT SENSOR	CS
				EMS MOTORIZED DUCT DAMPER/PIPE VALVE ACTUATOR	—

GENERAL MECHANICAL NOTES:

- THE INTENT OF THE DRAWING AND SPECIFICATIONS IS TO CONSTRUCT THE BUILDING IN ACCORDANCE WITH THE 2022 EDITION OF TITLE 24, CALIFORNIA CODE OF REGULATIONS. CHANGES TO THE STRUCTURAL ACCESSIBILITY OR FIRE AND LIFE SAFETY PORTIONS SHALL BE MADE BY AN ADDENDUM OR CONSTRUCTION ORDER. THE CONTRACTOR SHALL SUBMIT A COMMENCEMENT OF THE WORK.
- LAYOUT OF MATERIALS, EQUIPMENT AND SYSTEMS IS DIMENSIONED. SOME WORK MAY BE SHOWN OFFSET. BEEN PREPARED TO MATCH THE ARCHITECTURAL PLANS. IF DIFFERENCES OCCUR, THE ARCHITECTURAL PLANS ARE TO TAKE PRECEDENCE. THE ACTUAL LOCATIONS OF ALL MATERIALS, PIPING, DUCTWORK, FIXTURES, EQUIPMENT, SUPPORTS, ETC. SHALL BE CAREFULLY PLANNED. PRIOR TO INSTALLATION OF ANY WORK TO AVOID ALL INTERFERENCES WITH EACH OTHER, OR WITH STRUCTURAL, ELECTRICAL, ARCHITECTURAL, OR OTHER ELEMENTS. ALL DUCT AND PIPE OFFSET ELBOWS FOR COORDINATION BETWEEN TRADES ARE NOT SHOWN. CONTRACTOR SHALL INCLUDE SUFFICIENT FUNDS FOR THE COORDINATION OFFSETS IN THE BID. VERIFY THE PROPER VOLTAGE AND PHASE OF ALL EQUIPMENT WITH THE ELECTRICAL PLANS. ALL CONFLICTS SHALL BE CALLED TO THE ATTENTION OF THE ARCHITECT AND THE ENGINEER PRIOR TO THE INSTALLATION OF ANY WORK OR THE ORDERING OF ANY EQUIPMENT.
- PENETRATIONS OF PIPES, CONDUITS, ETC. IN WALLS OR FLOORS REQUIRING PROTECTED OPENINGS SHALL BE FIRE STOPPED INCLUDING EXISTING PIPE AND CONDUIT THROUGH NEW WALLS AND FLOORS. SEE DETAIL.
- ALL PIPING, DUCTWORK AND CONDUIT REQUIRING SEISMIC BRACE AND SUPPORT SHALL BE SUPPORTED PER MASON INDUSTRIES, INC. "SEISMIC RESTRAINT COMPONENTS FOR SUSPENDED UTILITIES". HCAI (OSHPD) PREAPPROVED ANCHORAGE OPM-0043-13 OR OTHER HCAI (OSHPD) PREAPPROVED SYSTEM.
- WHEN INSTALLING DRILLED-IN ANCHORS AND/OR POWDER-DRIVEN PINS IN EXISTING NON-PRESTRESSED CONCRETE, USE CARE AND CAUTION TO AVOID CUTTING OR DAMAGING THE EXISTING REINFORCING BARS. WHEN INSTALLING THEM INTO EXISTING PRESTRESSED CONCRETE (PRE-OR POST-TENSIONED), LOCATE THE PRESTRESSED TENDONS BY USING A NON-DESTRUCTIVE METHOD PRIOR TO INSTALLATION. EXERCISE EXTREME CARE AND CAUTION TO AVOID CUTTING OR DAMAGING THE TENDONS DURING INSTALLATION. MAINTAIN A MINIMUM CLEARANCE OF ONE INCH BETWEEN THE REINFORCEMENT AND THE DRILLED-IN ANCHOR AND/OR PIN.
- ALL MECHANICAL, PLUMBING, AND ELECTRICAL COMPONENTS SHALL BE ANCHORED AND INSTALLED PER THE DETAILS ON THE APPROVED CONSTRUCTION DOCUMENTS. WHERE THERE IS NO DETAIL, IS INDICATED, THE FOLLOWING COMPONENTS SHALL BE ANCHORED OR BRACED TO MEET THE FORCE AND DISPLACEMENT REQUIREMENTS PRESCRIBED IN THE 2022 CBC, SECTIONS 1617A.1.18 THROUGH 1617A.1.26 AND ASCE 7-16 CHAPTERS 13, 26 AND 30.
  - ALL PERMANENT EQUIPMENT AND COMPONENTS.
  - TEMPORARY OR MOVABLE EQUIPMENT THAT IS PERMANENTLY ATTACHED (E.G. HARD WIRED) TO THE BUILDING UTILITY SERVICES SUCH AS ELECTRICAL, GAS, OR WATER.
  - MOVABLE EQUIPMENT WHICH IS STATIONED IN ONE PLACE FOR MORE THAN 8 HOURS AND HEAVIER THAN 400 LBS ARE REQUIRED TO BE ANCHORED WITH TEMPORARY ATTACHMENTS.
- DUCTWORK SIZES SHOWN ARE INSIDE CLEAR DIMENSIONS. WHERE ACOUSTIC LINING IS SHOWN, INCREASE EACH SHEET METAL DIMENSION TO ACCOMMODATE LINING & MAINTAIN CLEAR INSIDE DUCT DIMENSIONS SHOWN.
- SA DUCTWORK FOR VAV SYSTEMS SHALL BE 2" PRESSURE CLASS UPSTREAM OF BOXES AND 1" DOWNSTREAM OF BOXES, AND SA DUCTWORK SHALL BE 1" PRESSURE CLASS AND RA & EA DUCTWORK SHALL BE 1" PRESSURE CLASS UNLESS OTHERWISE NOTED.

**THIS SHEET IS FOR REFERENCE ONLY**  
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FOR MECHANICAL WORK TO BE ACCOMPLISHED IN THIS AREA, REFER TO SHEETS M200-204 & M300-M304.

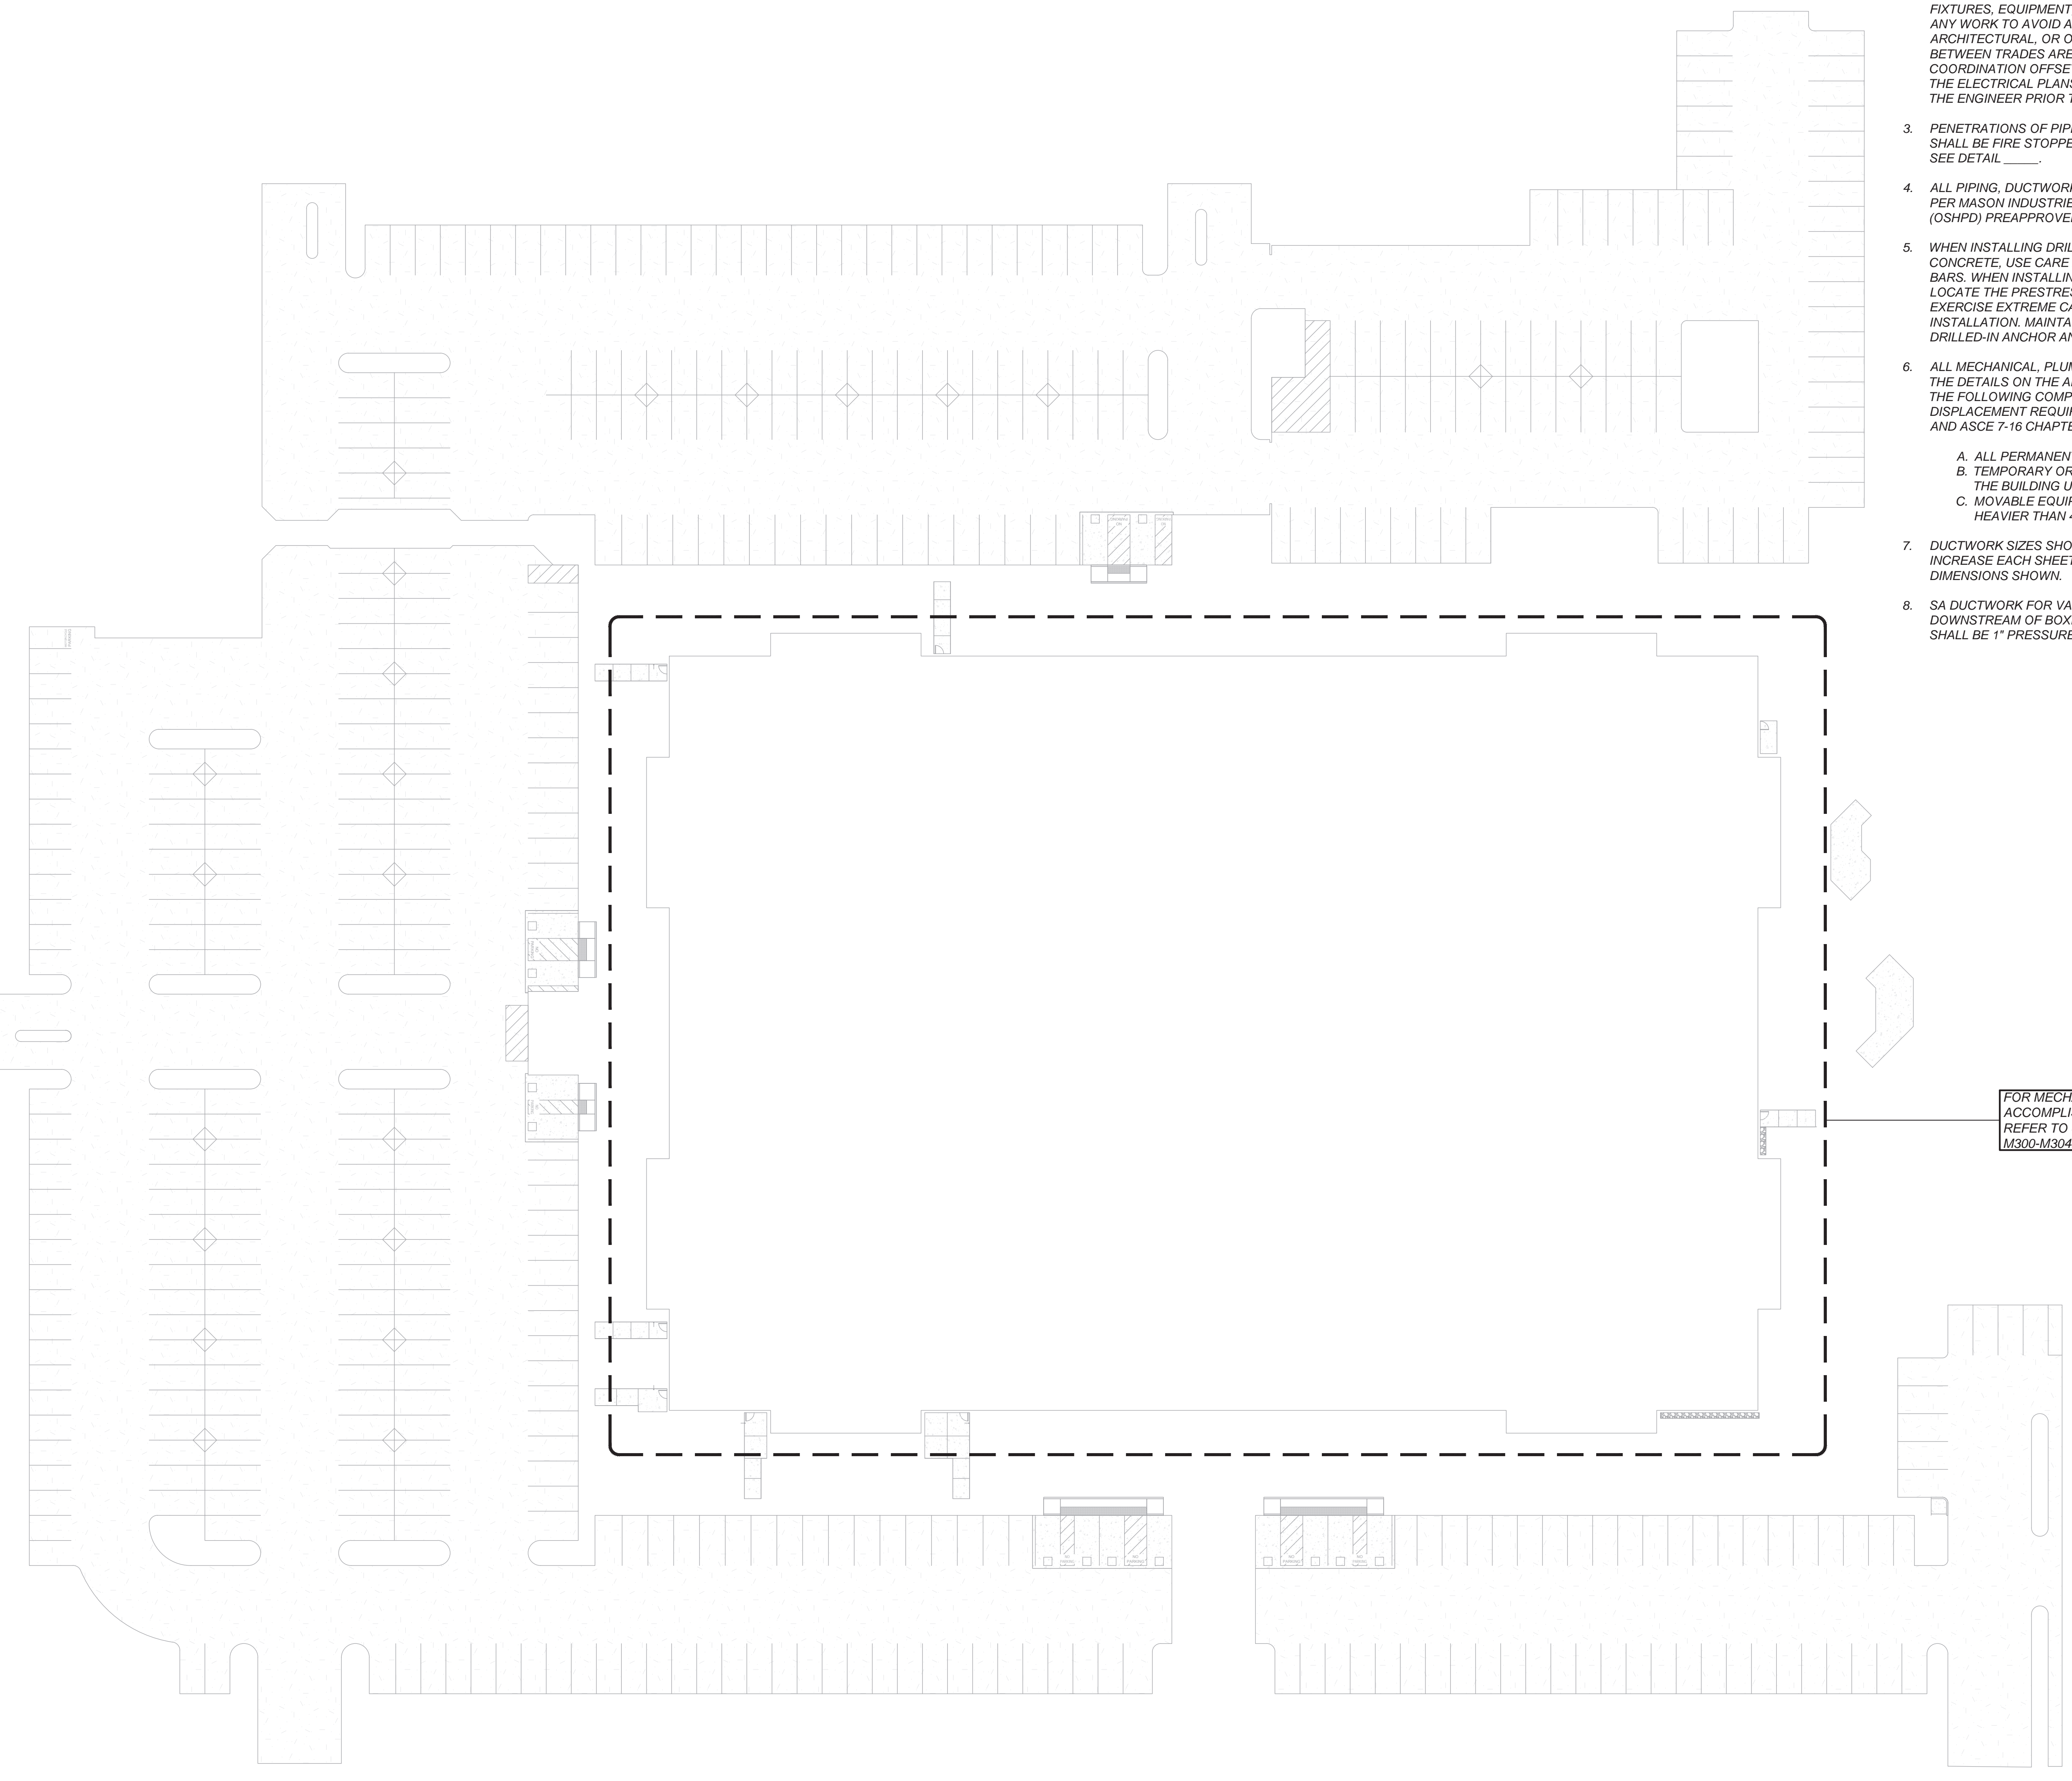

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**LAWRENCE ENGINEERING GROUP**  
1110 E. Clinton Way, Suite 101, 24069 Fresno, CA 93727  
509.431-6161 FAX 509.431-1342

**PRELIMINARY**  
NOT FOR CONSTRUCTION  
STATE OF CALIFORNIA  
ARCHITECT: Barry Lynn Mack, Architect  
California License Architect No. C 38749  
Rev. 12-31-2025  
Fresno County Department of Public Works and Planning  
Development Services and Capital Projects Division  
2220 Tulare Street, 8th Floor  
Fresno, California 93721  
Office: (558) 400-4536  
Email: bnmack@fresnocountyca.gov

**Project:**  
THE COUNTY OF FRESNO  
DEPARTMENT OF BEHAVIORAL HEALTH  
OLIVE AVE CAMPUS REMODEL  
5555 E Olive Avenue, Fresno, California  
APN: 45522312ST  
Issue date: 2024-08-02  
Project no.: T80317  
File name: M100 Site Plan and Notes

**Sheet Content:**  
**SITE PLAN AND NOTES**

Fresno County Department of Public Works and Planning  
Capital Projects  
2220 Tulare Street, 8th Floor  
Fresno, California 93721

Sheet No.:  
**M-100**

# MECHANICAL SITE PLAN

Scale: 1" = 30'-0"

VARIABLE AIR VOLUME (VAV) TERMINAL BOX WITH ELECTRIC RE-HEAT SCHEDULE

Table with 18 columns (DESIGNATION, VAV 1-18) and 18 rows (DESIGN CFM, MINIMUM CFM, INLET PRESSURE, INTERNAL PD, MAX NC, HEATING AIRFLOW, HEATING CAPACITY, HEATING STAGES, VOLTAGE / PHASE, MCA / MOCP, ELEC. RESISTANCE, EADB / LABD, MANUFACTURER, MODEL, UNIT SIZE, LOCATION, ZONE, OPER. WT., ACCESSORIES).

- 1. DOUBLE WALL CONSTRUCTION WITH 1" FIBERGLASS INSULATION
2. CERTIFIED ULTRA-LOW AIR LEAKAGE
3. EMS TO PROVIDE FIELD CONTROLLER
4. MANUFACTURER PROVIDED NEMA 1 CONTROL BOX AND DAMPER ACTUATOR FOR CONTROL INTEGRATION
5. ELECTRICAL TO PROVIDE SEPARATE 115V CIRCUIT FOR CONTROLS
\* REFER TO MANUFACTURER CUT-SHEETS FOR INLET, OUTLET, AND PHYSICAL DIMENSIONS

THIS SHEET IS FOR REFERENCE ONLY NOT FOR CONSTRUCTION

VARIABLE AIR VOLUME (VAV) TERMINAL BOX WITH ELECTRIC RE-HEAT SCHEDULE

Table with 20 columns (DESIGNATION, VAV 1-20) and 20 rows (DESIGN CFM, MINIMUM CFM, INLET PRESSURE, INTERNAL PD, MAX NC, HEATING AIRFLOW, HEATING CAPACITY, HEATING STAGES, VOLTAGE / PHASE, MCA / MOCP, ELEC. RESISTANCE, EADB / LABD, MANUFACTURER, MODEL, UNIT SIZE, LOCATION, ZONE, OPER. WT., ACCESSORIES).

- 1. DOUBLE WALL CONSTRUCTION WITH 1" FIBERGLASS INSULATION
2. CERTIFIED ULTRA-LOW AIR LEAKAGE
3. EMS TO PROVIDE FIELD CONTROLLER
4. MANUFACTURER PROVIDED NEMA 1 CONTROL BOX AND DAMPER ACTUATOR FOR CONTROL INTEGRATION
5. ELECTRICAL TO PROVIDE SEPARATE 115V CIRCUIT FOR CONTROLS
\* REFER TO MANUFACTURER CUT-SHEETS FOR INLET, OUTLET, AND PHYSICAL DIMENSIONS

VARIABLE AIR VOLUME (VAV) TERMINAL BOX WITH ELECTRIC RE-HEAT SCHEDULE

Table with 20 columns (DESIGNATION, VAV 1-20) and 20 rows (DESIGN CFM, MINIMUM CFM, INLET PRESSURE, INTERNAL PD, MAX NC, HEATING AIRFLOW, HEATING CAPACITY, HEATING STAGES, VOLTAGE / PHASE, MCA / MOCP, ELEC. RESISTANCE, EADB / LABD, MANUFACTURER, MODEL, UNIT SIZE, LOCATION, ZONE, OPER. WT., ACCESSORIES).

- 1. DOUBLE WALL CONSTRUCTION WITH 1" FIBERGLASS INSULATION
2. CERTIFIED ULTRA-LOW AIR LEAKAGE
3. EMS TO PROVIDE FIELD CONTROLLER
4. MANUFACTURER PROVIDED NEMA 1 CONTROL BOX AND DAMPER ACTUATOR FOR CONTROL INTEGRATION
5. ELECTRICAL TO PROVIDE SEPARATE 115V CIRCUIT FOR CONTROLS
\* REFER TO MANUFACTURER CUT-SHEETS FOR INLET, OUTLET, AND PHYSICAL DIMENSIONS



Project: THE COUNTY OF FRESNO DEPARTMENT OF BEHAVIORAL HEALTH OLIVE AVE CAMPUS REMODEL
Issue date: 2024-08-02
Project no.: T80317
File name: M101-M104 Mechanical Schedules

Sheet Content: MECHANICAL SCHEDULES



Sheet No.: M-101







EXHAUST FAN SCHEDULE													
DESIGNATION	EF 1	EF 2	EF 3	EF 4	EF 5	EF 6	EF 7	EF 8	EF 9	EF 10	EF 11	EF 12	EF 13
CFM	1125	200	1025	975	200	1225	300	200	100	100	100	50	100
EXT. S.P. (IN. WC)	0.2"	0.2"	0.2"	0.2"	0.2"	0.2"	0.5"	0.2"	0.1"	0.1"	0.1"	0.1"	0.1"
HP / BHP	1/4 / 0.19	1/8 / 0.02	1/8 / 0.15	1/8 / 0.15	1/8 / 0.02	1/2 / 0.23	1/8 / 0.04	1/8 / 0.02	1/20 / 0.03	1/20 / 0.03	1/20 / 0.03	1/30 / 0.02	1/20 / 0.03
VOLTS / PHASE	115/1	115/1	115/1	115/1	115/1	115/1	115/1	115/1	115/1	115/1	115/1	115/1	115/1
RPM	1507	1231	1595	1532	1231	1620	1519	1231	608	608	608	634	608
TIP SPEED/SONES	- / 12.7	- / 4.2	- / 12.1	- / 11.2	- / 4.2	- / 14.6	- / 4.8	- / 4.8	- / -	- / -	- / -	- / -	- / -
DRIVE	DIRECT	DIRECT	DIRECT	DIRECT	DIRECT	DIRECT	DIRECT	DIRECT	DIRECT	DIRECT	DIRECT	DIRECT	DIRECT
MOUNTING	CURB	CURB	CURB	CURB	CURB	CURB	CURB	CURB	CEILING	CEILING	CEILING	CEILING	CEILING
MANUFACTURER	TWIN CITY	TWIN CITY	TWIN CITY	TWIN CITY	TWIN CITY	TWIN CITY	TWIN CITY	TWIN CITY	TWIN CITY	TWIN CITY	TWIN CITY	TWIN CITY	TWIN CITY
TYPE	DOWNBLAST	DOWNBLAST	DOWNBLAST	DOWNBLAST	DOWNBLAST	DOWNBLAST	DOWNBLAST	DOWNBLAST	CEILING	CEILING	CEILING	CEILING	CEILING
MODEL NUMBER	VC-120	VC-085	VC-112	VC-112	VC-085	VC-120	VC-089	VC-089	T-150LPH	T-150LPH	T-150LPH	T-080LPH	T-150LPH
CONTROL	ECM	ECM	ECM	ECM	ECM	ECM	ECM	ECM	-	-	-	-	-
SERVES	AC-5	AC-7	AC-19	AC-20	AC-13	AC-14	AC-16, 21 & 23	AC-17	-	-	-	-	-
LOCATION	ROOF	ROOF	ROOF	ROOF	ROOF	ROOF	ROOF	ROOF	620	713	249	839	924
OPER. WT. (LBS)	100	80	80	80	80	100	80	80	15	15	15	15	15
ACCESSORIES	1 2 3 4 5	1 2 3 4 5	1 2 3 4 5	1 2 3 4 5	1 2 3 4 5	1 2 3 4 5	1 2 3 4 5	1 2 3 4 5	2	2	2	2	2

1. PROVIDE WITH SLOPED CURB (12 INCHES MINIMUM)
2. FACTORY PROVIDED BIRDSCREEN AND ALUMINUM BACKDRAFT DAMPER
3. FACTORY PROVIDED 0-10 VDC
4. FACTORY PROVIDED NEMA 1 DISCONNECT SWITCH (UNFUSED) - FIELD INSTALLED
5. TITLE 20 COMPLIANT

GRILLE SCHEDULE		
MARK	DUTY	DESCRIPTION
A	CEILING SUPPLY	TITUS MCD (TYPE 3) MODULAR CORE DIFFUSER WITH SQUARE OR RECTANGULAR NECK DIFFUSER FOR STD. LAY-IN CEILING, AND NO. 26 OFF-WHITE FINISH. (18"x18" NECK ADAPTER SIZE SHOWN).
B	CEILING RETURN / EXHAUST	TITUS CORE 50F (TYPE 3) ALUMINUM EGG CRATE REGISTER WITH 1/2" x 1/2" GRID, FOR LAY-IN CEILING, AND NO. 26 OFF-WHITE FINISH.
C	CEILING SUPPLY	TITUS MCD (TYPE 1) MODULAR CORE DIFFUSER WITH SQUARE OR RECTANGULAR NECK DIFFUSER FOR SURFACE MOUNTING, AND NO. 26 OFF-WHITE FINISH.
D	CEILING RETURN / EXHAUST	TITUS CORE 50F (TYPE 1) ALUMINUM EGG CRATE REGISTER WITH 1/2" x 1/2" GRID, FOR SURFACE MOUNTING WITH NO. 26 OFF-WHITE FINISH.

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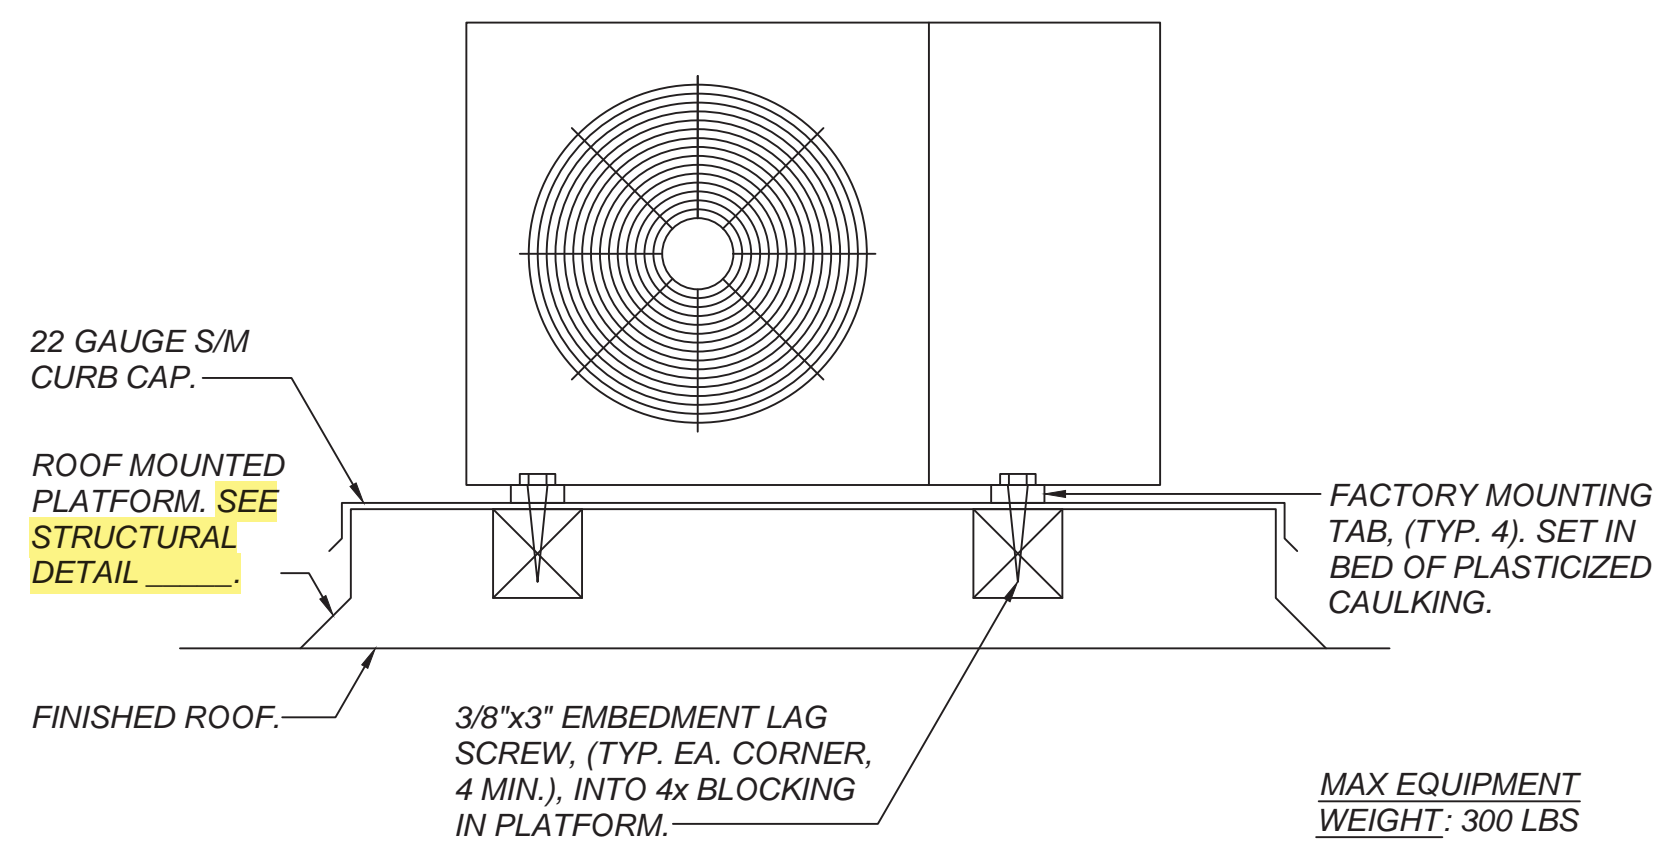
**PRELIMINARY**  
NOT FOR CONSTRUCTION  
STATE OF CALIFORNIA  
ARCHITECT: Barry Lynn Mack, Architect  
California License Architect No. C 38749  
Plan: 12-31-2025  
Fresno County Department of Public Works and Planning  
Development Services and Capital Projects Division  
2200 Tulare Street, 8th Floor  
Fresno, California 93721  
Office: (558) 400-4536  
Email: bmasi@fresnocountyca.gov

**Project:**  
THE COUNTY OF FRESNO  
DEPARTMENT OF BEHAVIORAL HEALTH  
OLIVE AVE CAMPUS REMODEL  
5555 E Olive Avenue, Fresno, California  
APN: 45522312ST  
Issue date: 2024-08-02  
Project no.: T80317  
File name: M101-M104 Mechanical Schedules


**Sheet Content:**  
**MECHANICAL SCHEDULES**

Fresno County Department of Public Works and Planning  
Capital Projects  
2220 Tulare Street, 8th Floor  
Fresno, California 93721


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**M-104**




**OUTDOOR UNIT MOUNTING DETAIL**  
SCALE: NONE

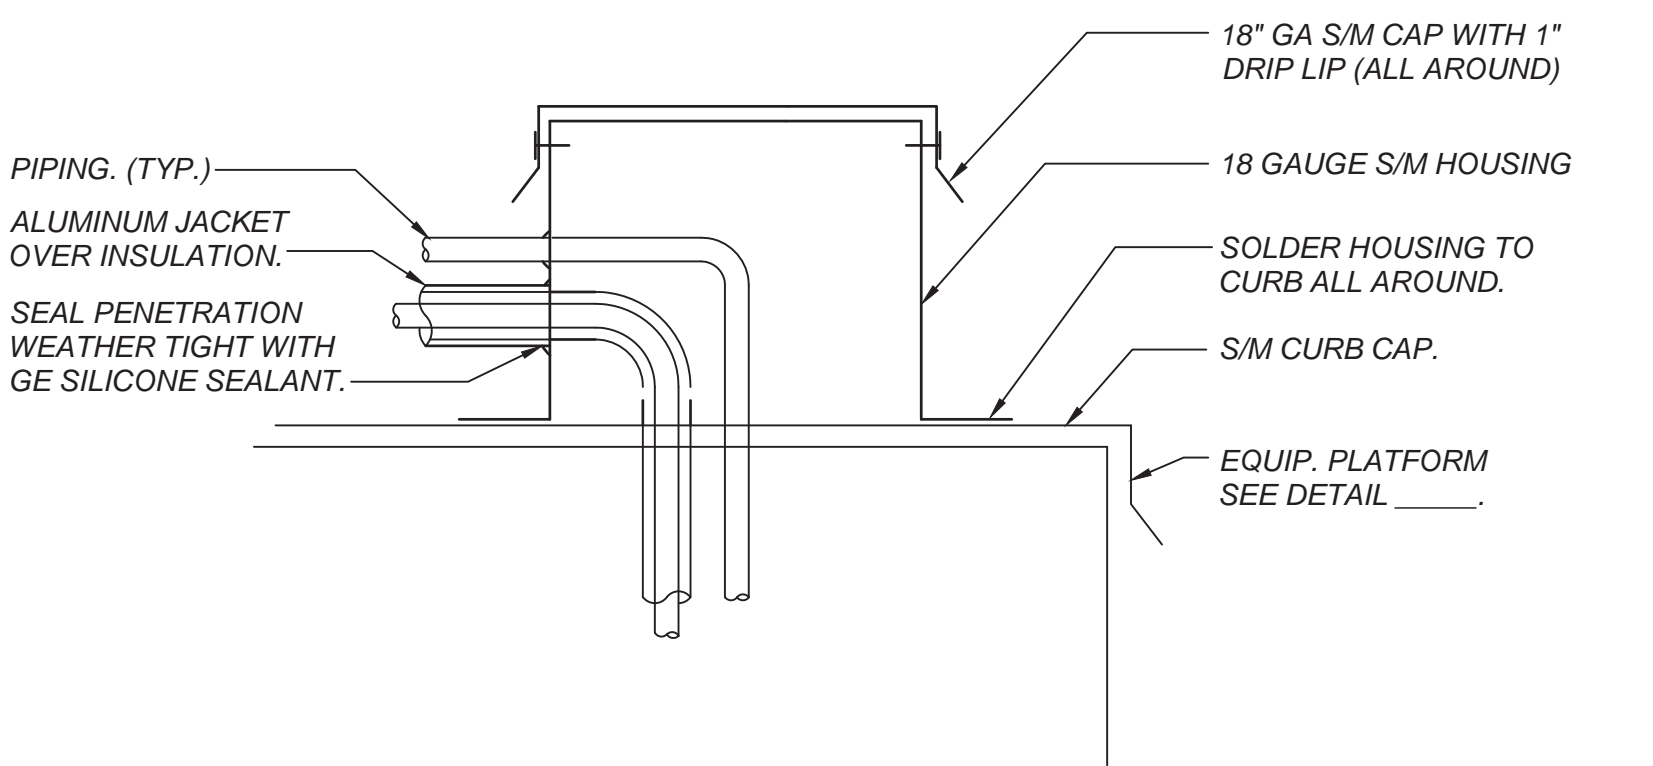


**PIPE THRU PLATFORM DETAIL**  
SCALE: NONE

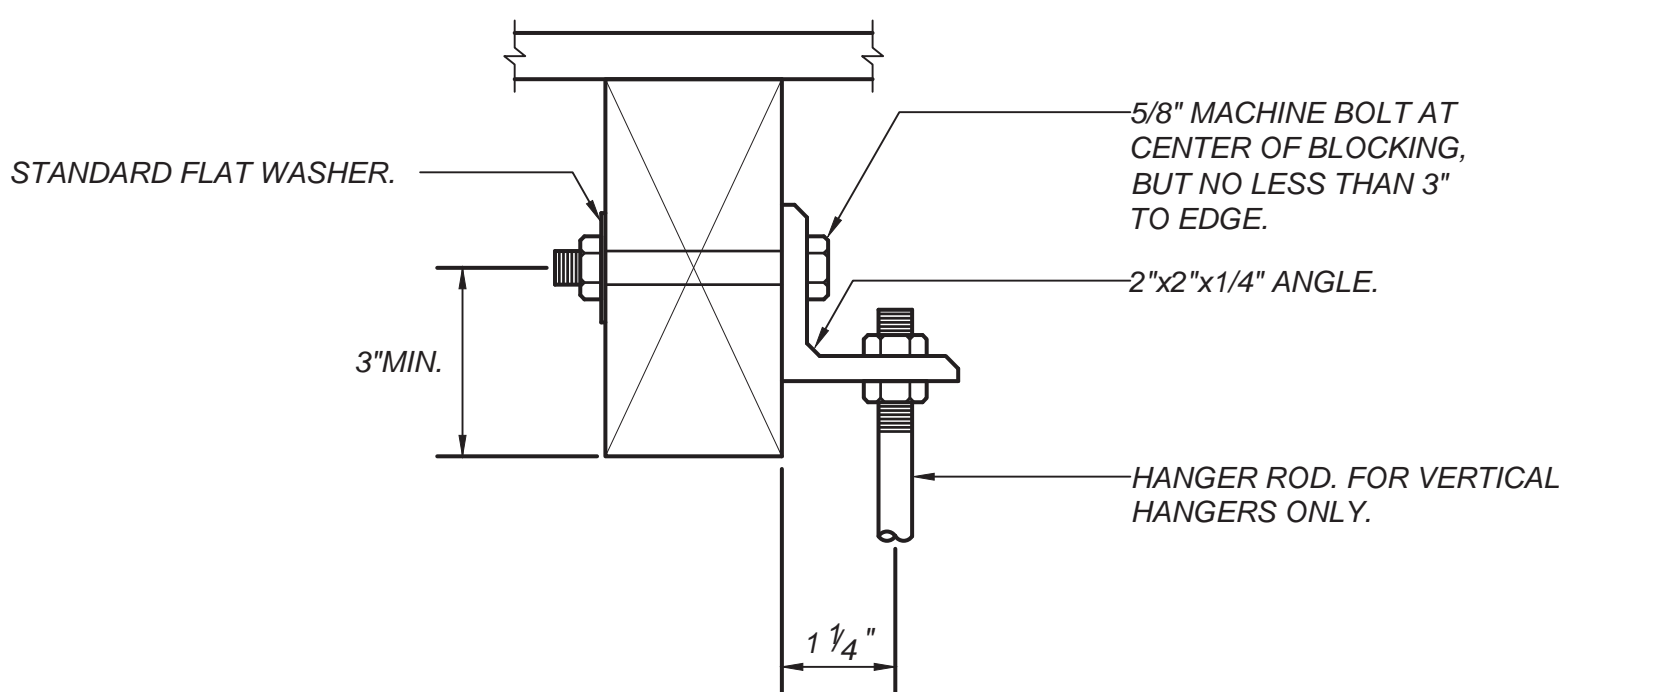


**UPPER HANGER CONNECTION**  
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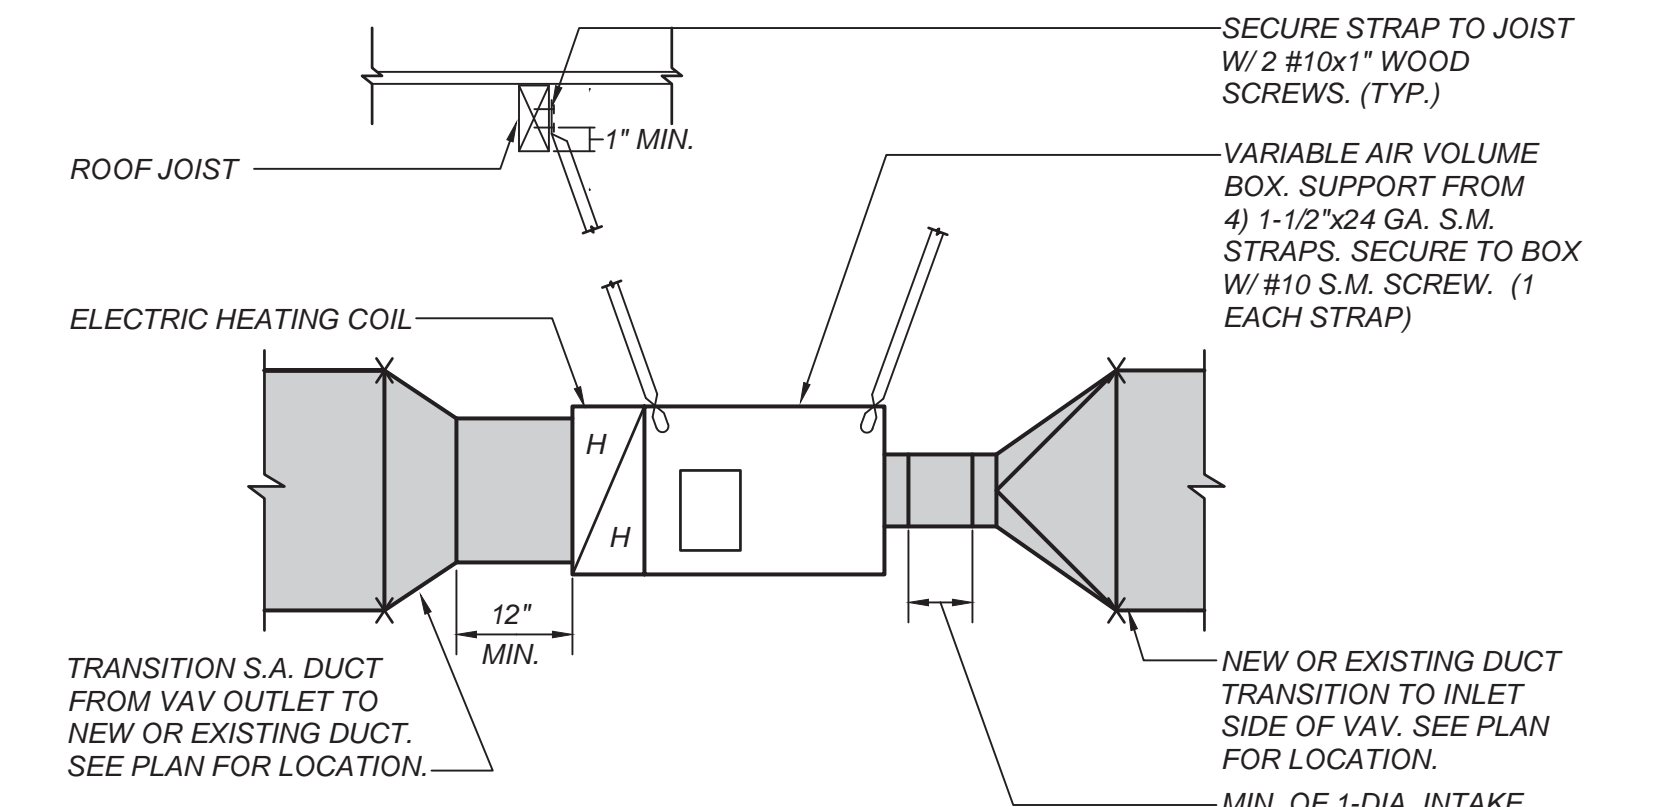
**SINGLE PIPE HANGING DETAIL**  
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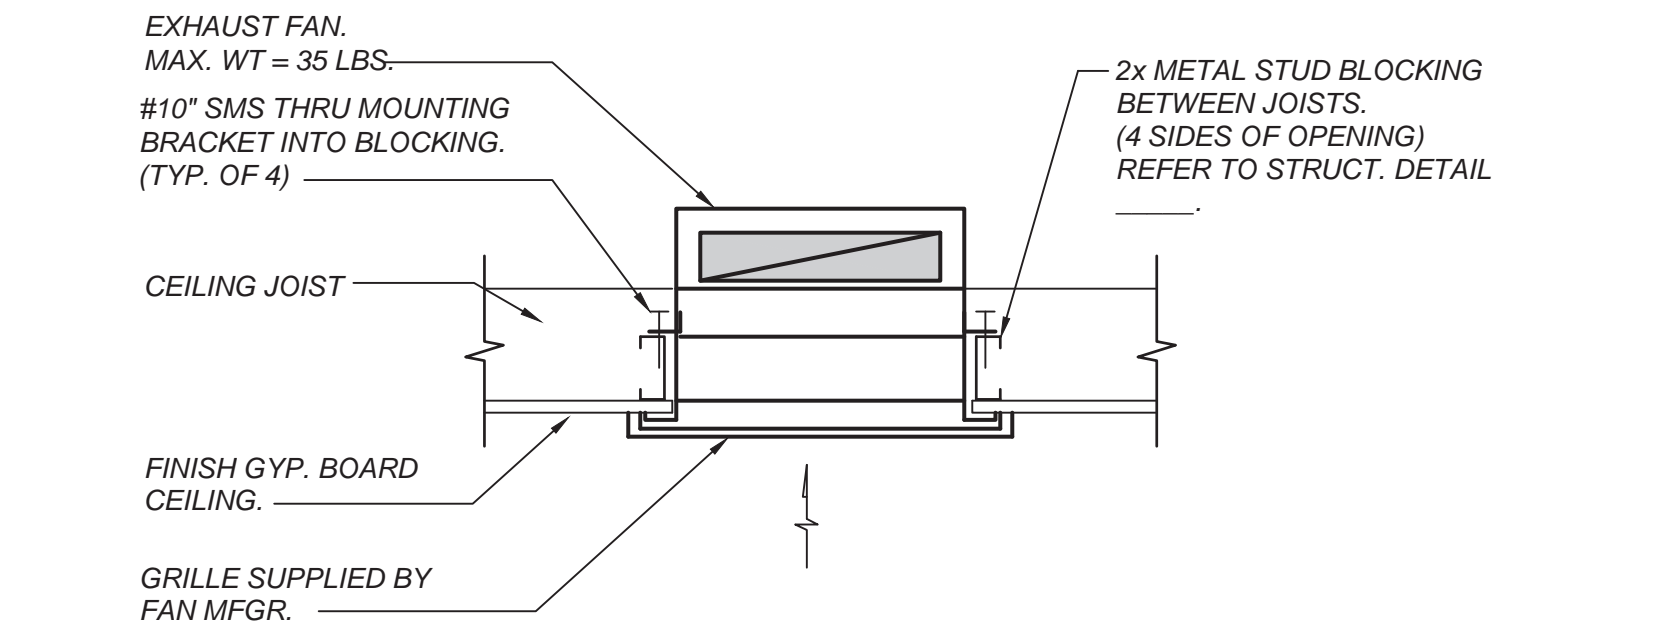
**AC UNIT MOUNTING DETAIL**  
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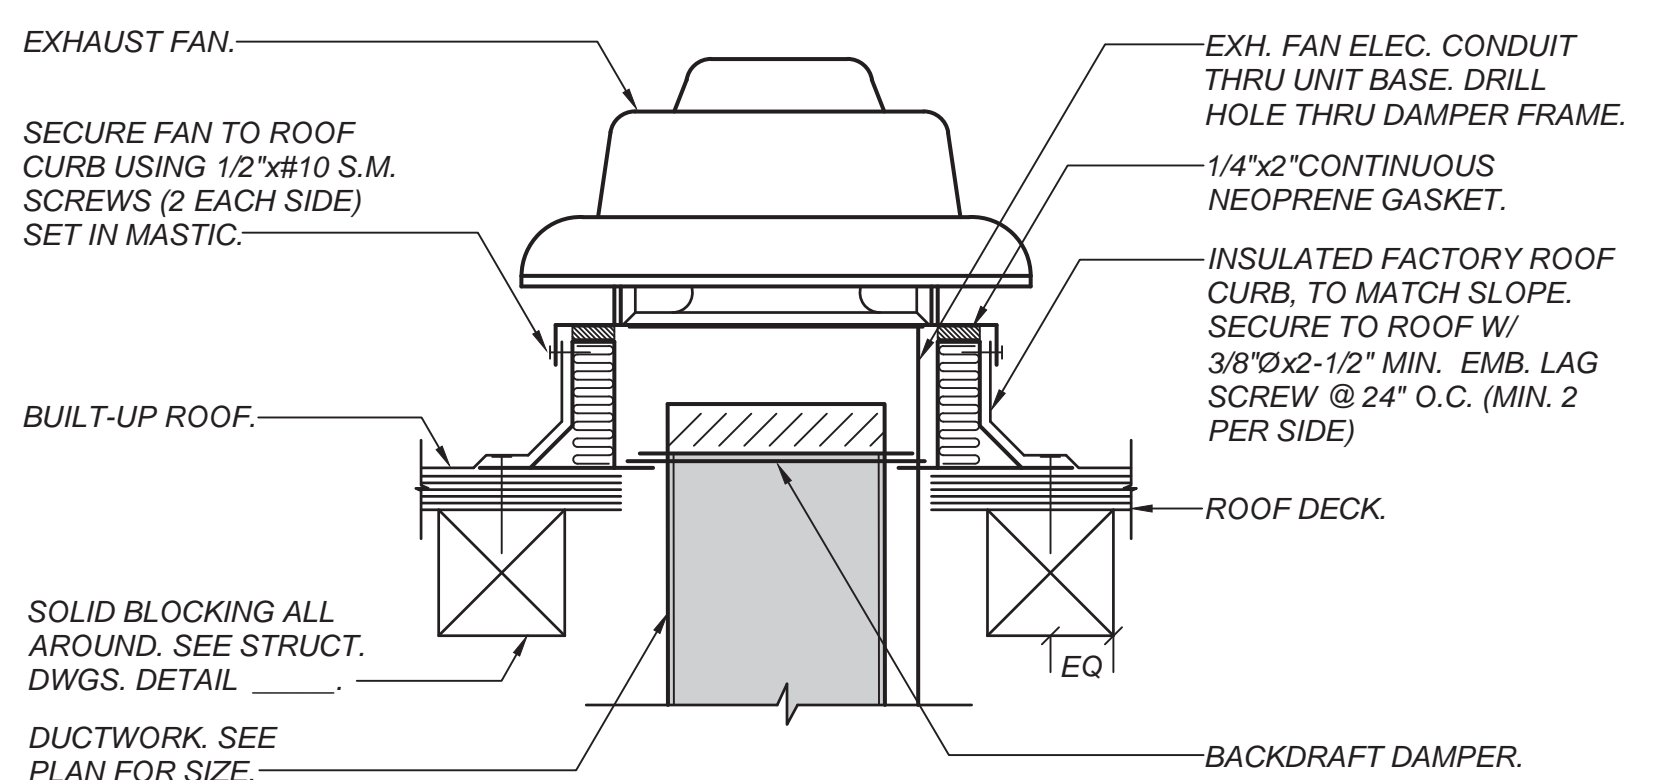
**RECTANGULAR DUCT HANGING DETAIL**  
SCALE: NONE

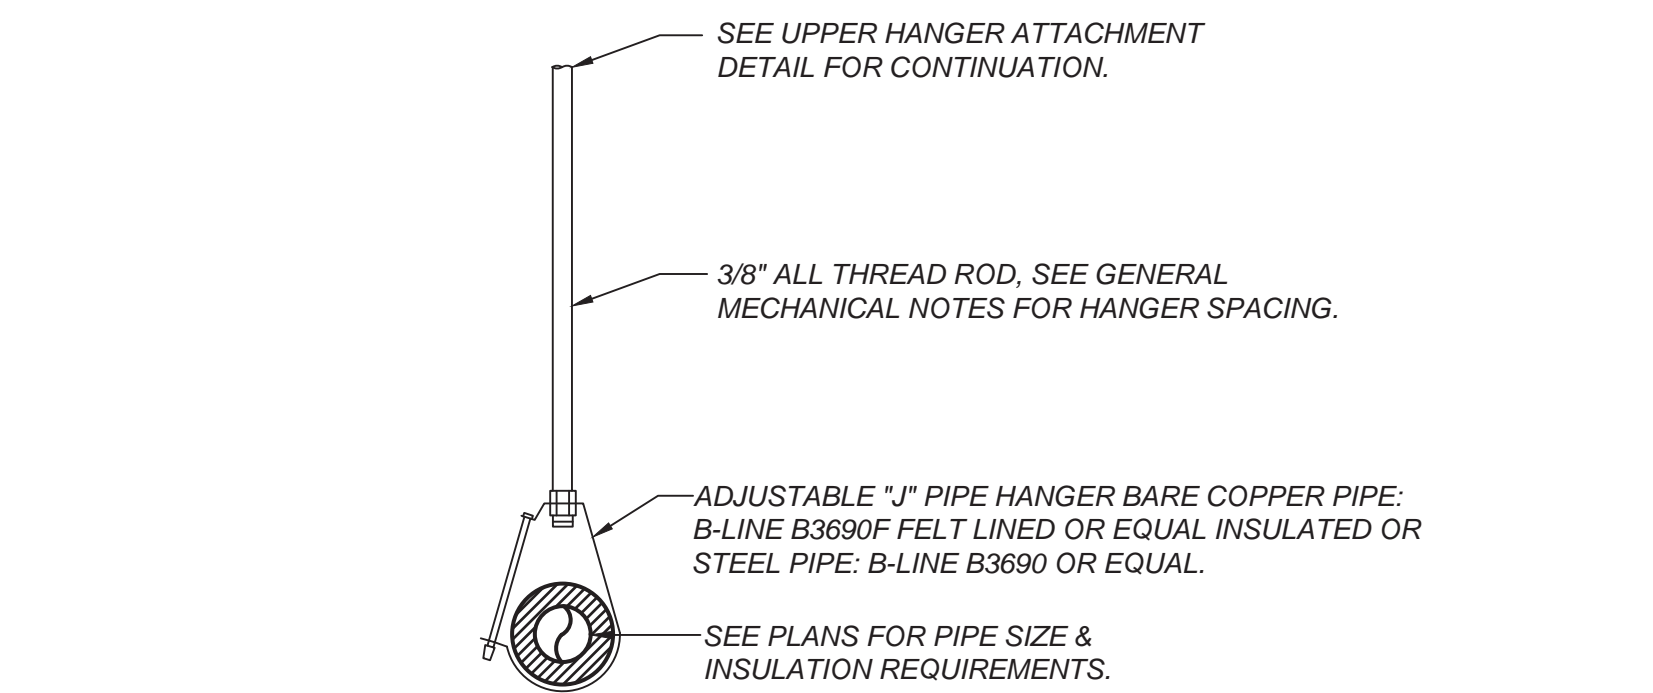


**VAV BOX MOUNTING DETAIL**  
SCALE: NONE

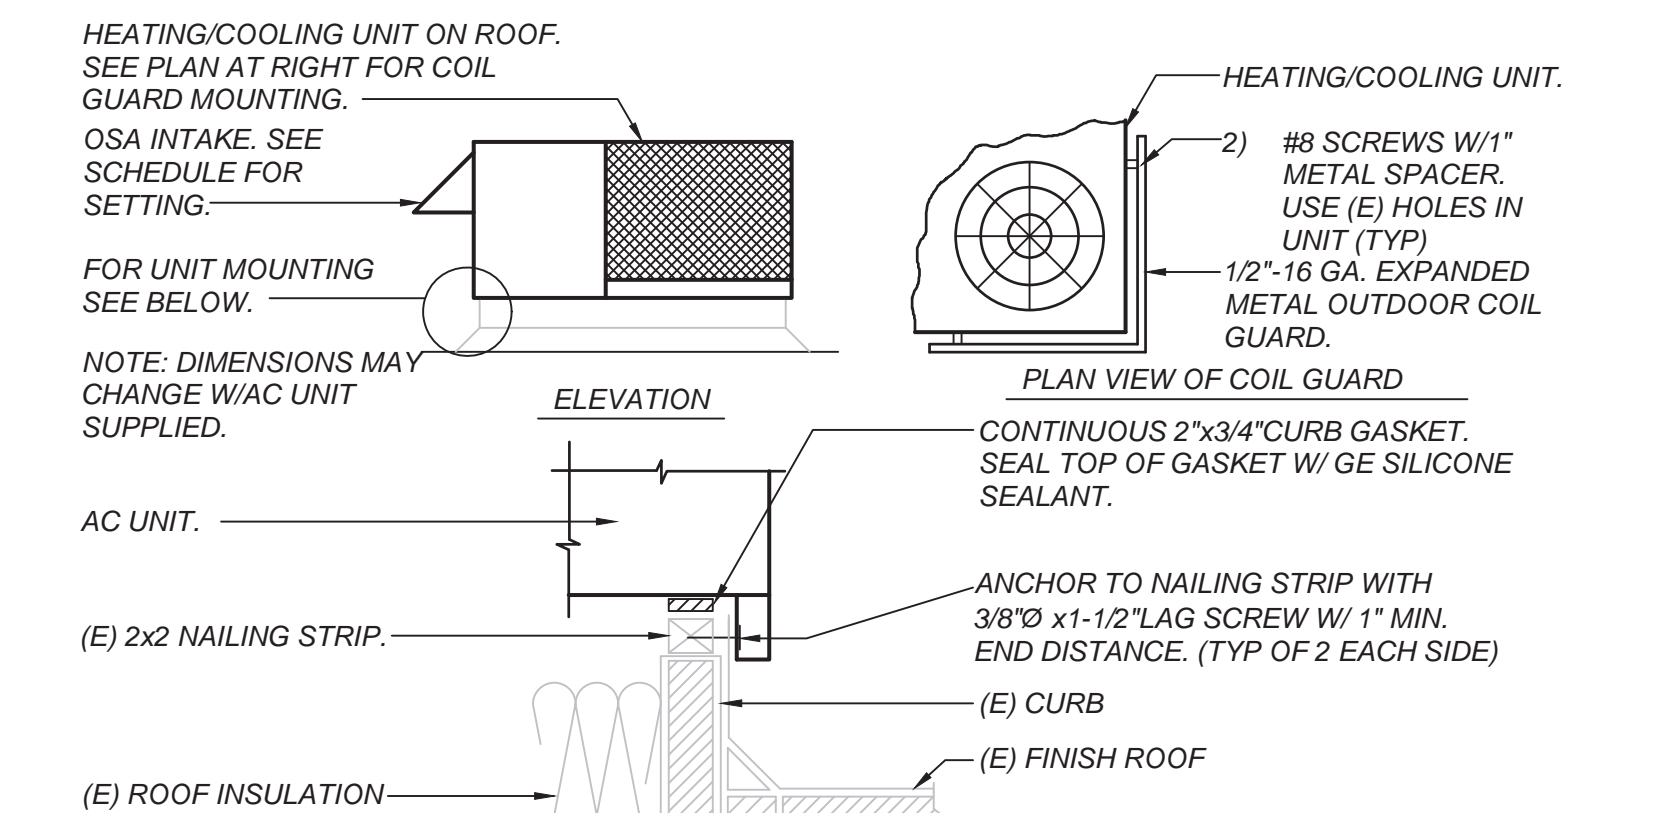


**CEILING EXHAUST FAN MOUNTING DETAIL**  
SCALE: NONE

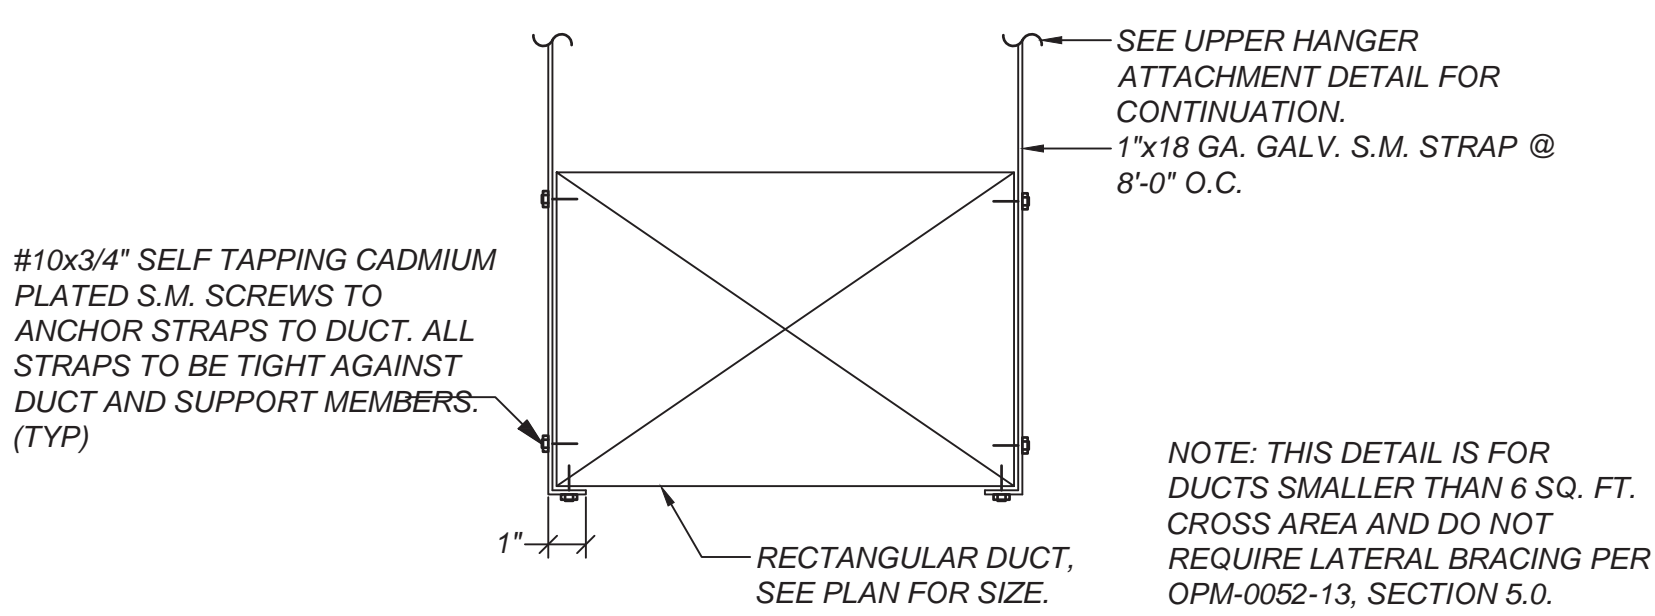


**ROOF EXHAUST FAN MOUNTING DETAIL**  
SCALE: NONE

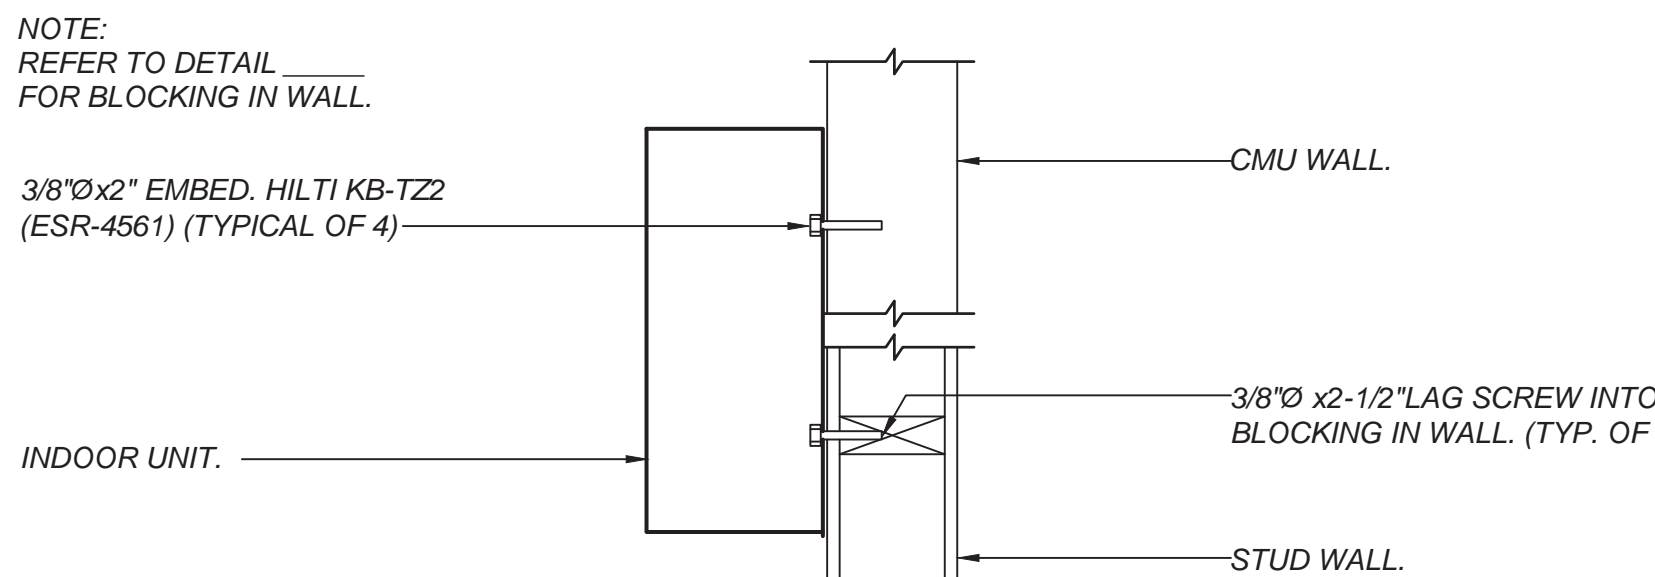


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SCALE: NONE

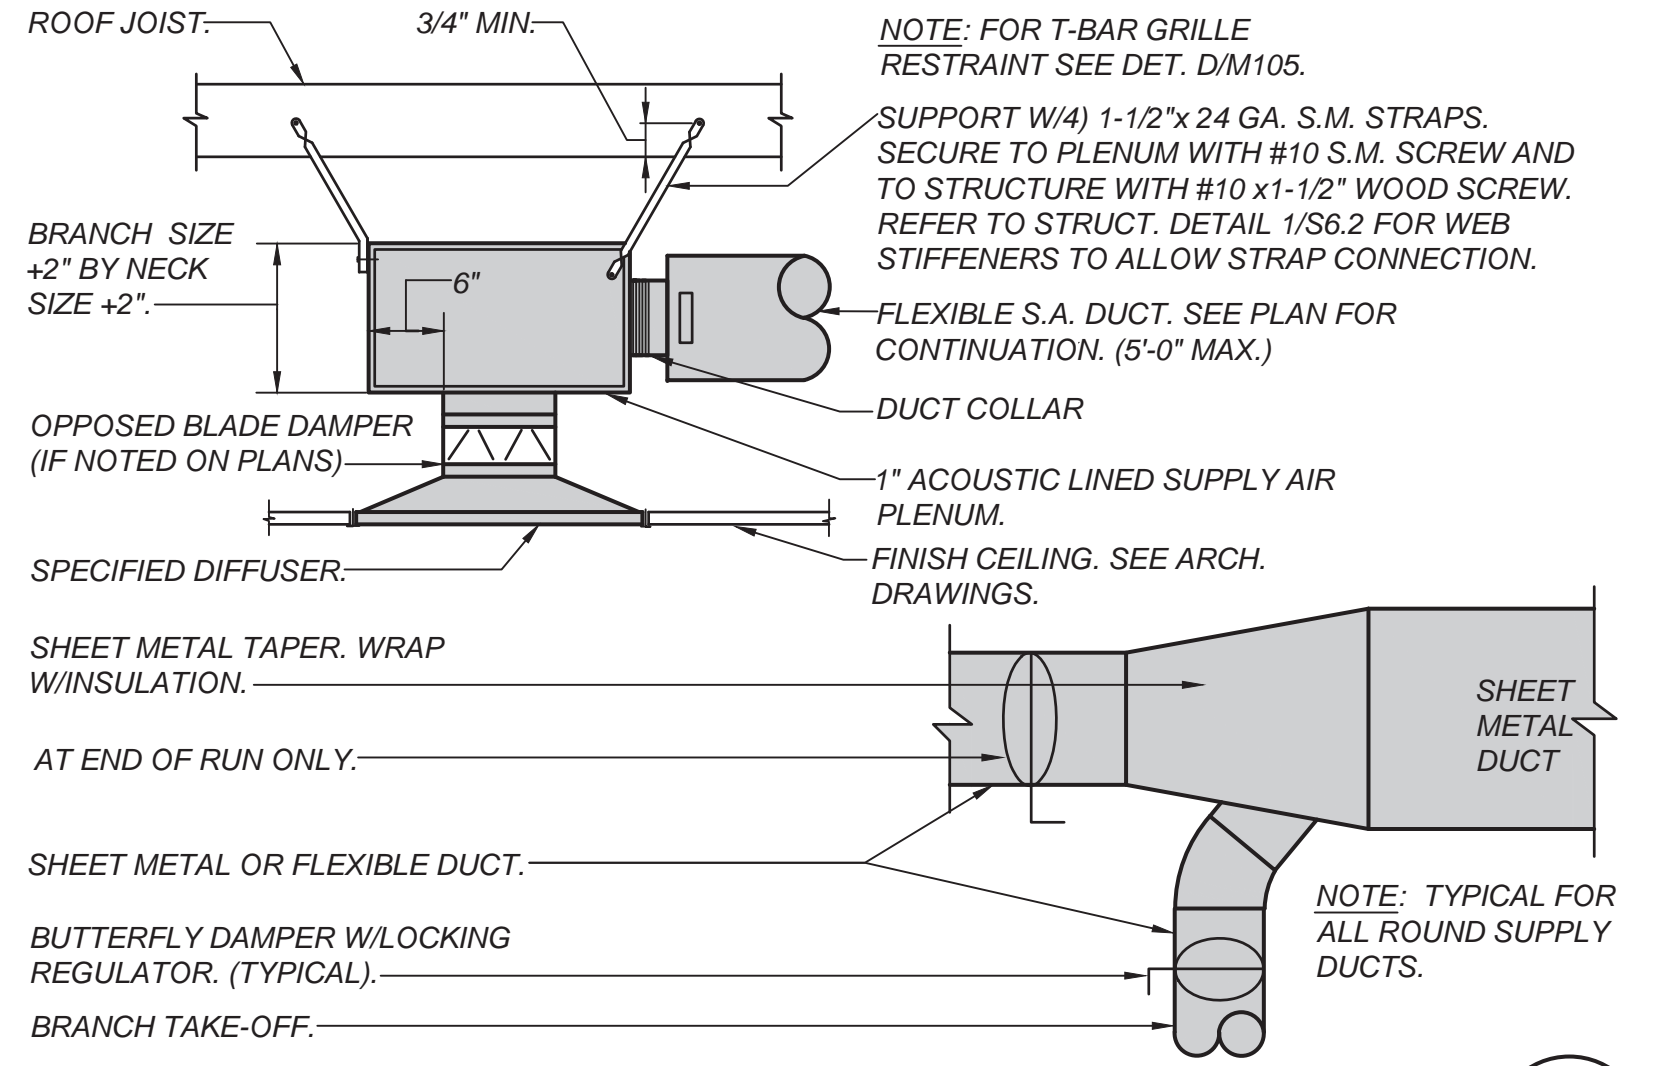


**TYPICAL S.A. DEVICE-BRANCH DUCT DETAIL**  
SCALE: NONE

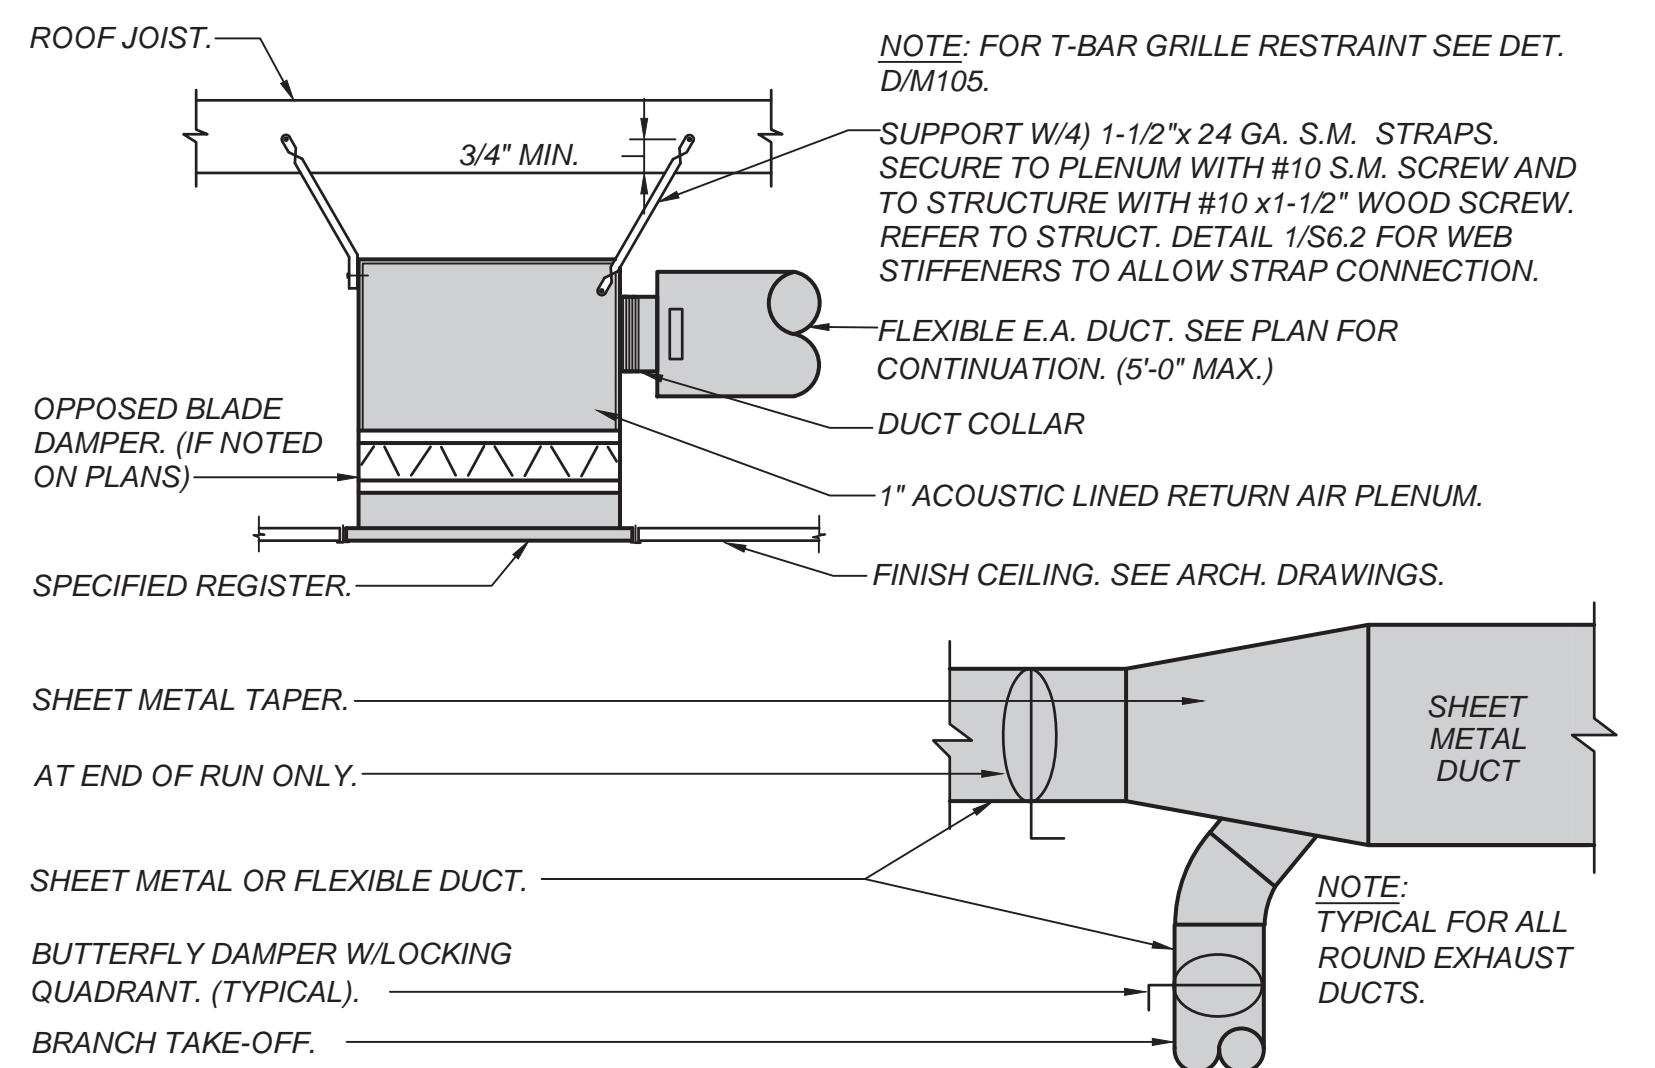


**TYPICAL E.A. DEVICE-BRANCH DUCT DETAIL**  
SCALE: NONE

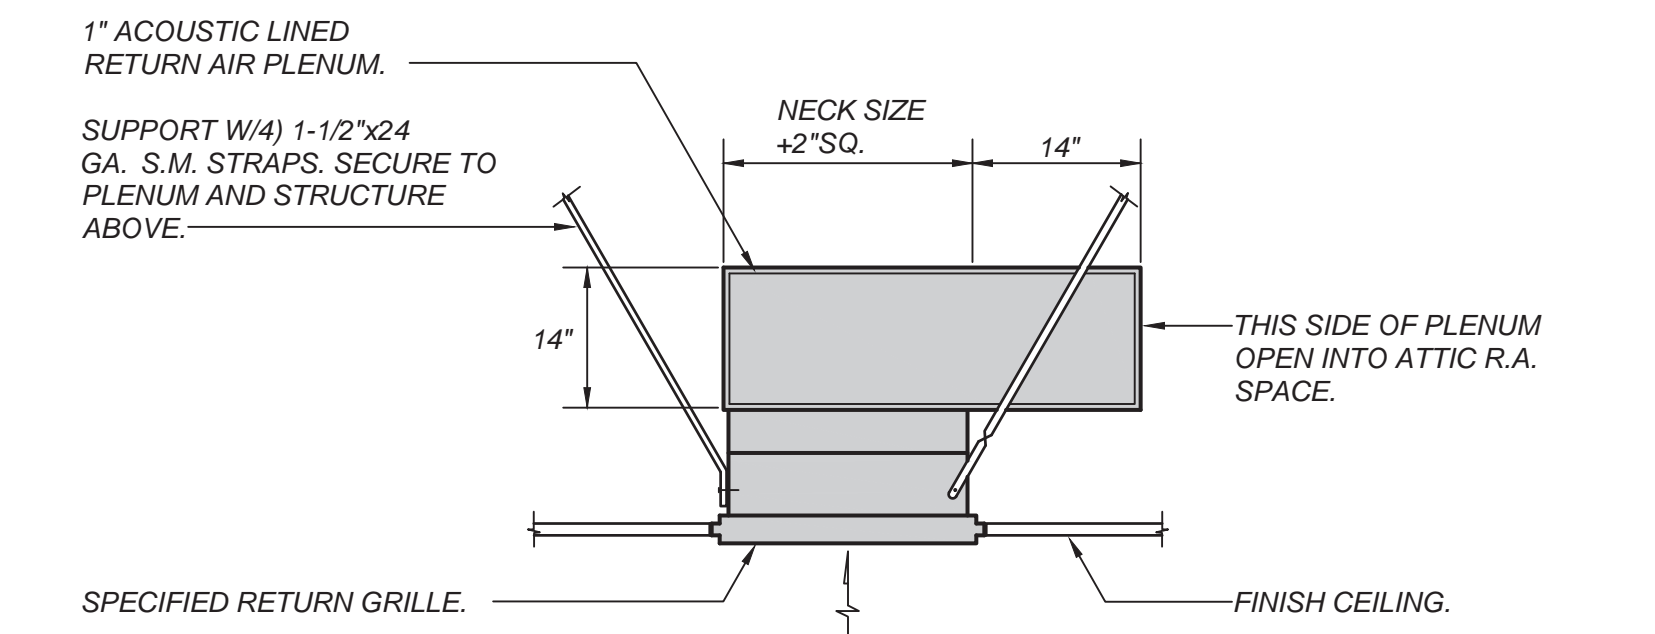

**RETURN AIR GRILLE DETAIL**  
SCALE: NONE

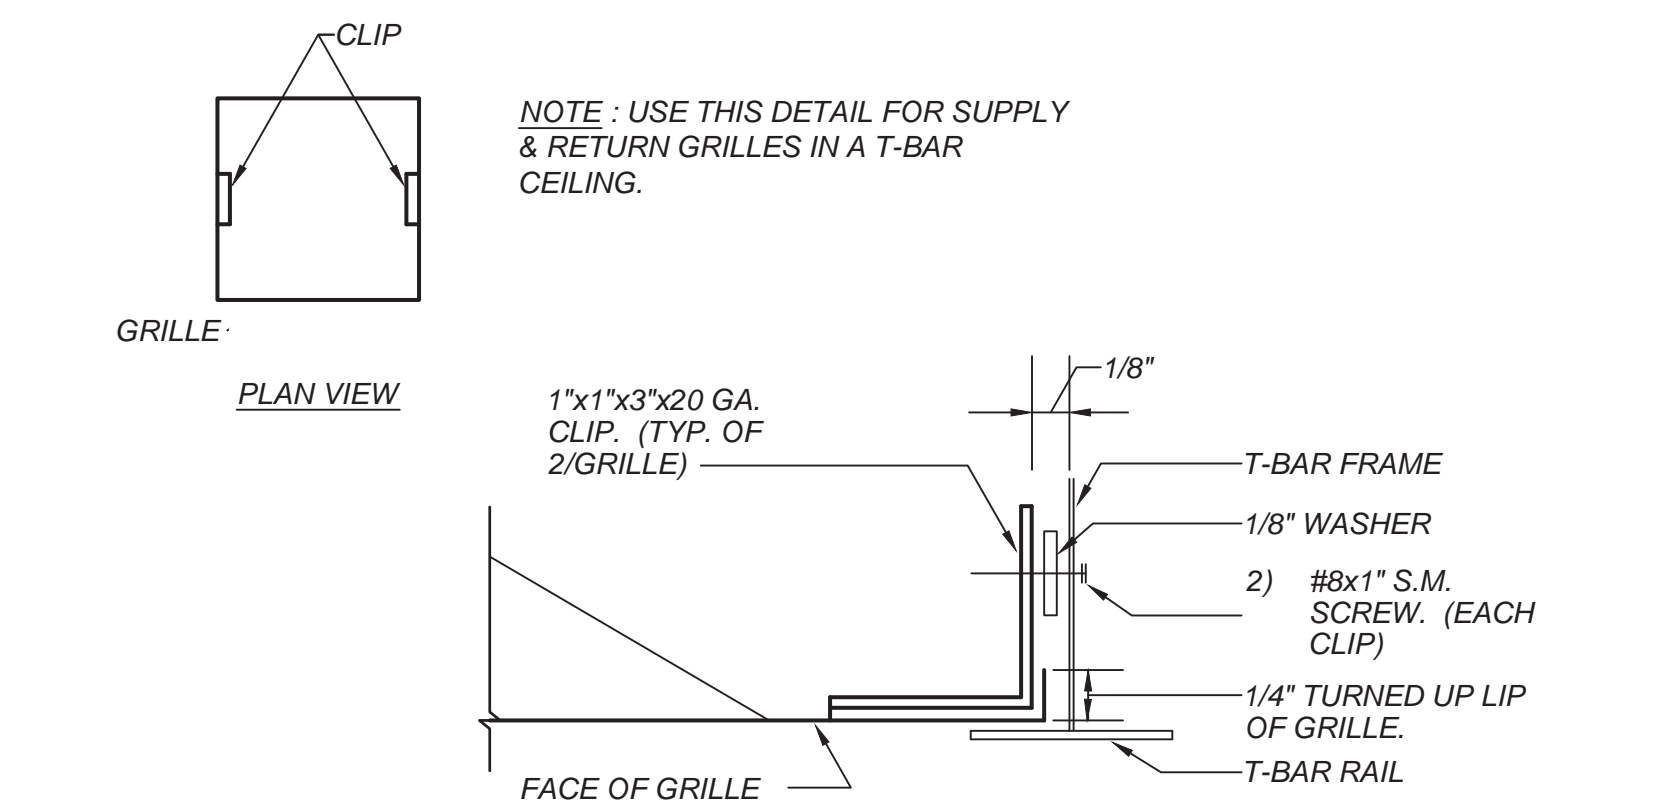

**GRILLE RESTRAINT DETAIL**  
SCALE: NONE

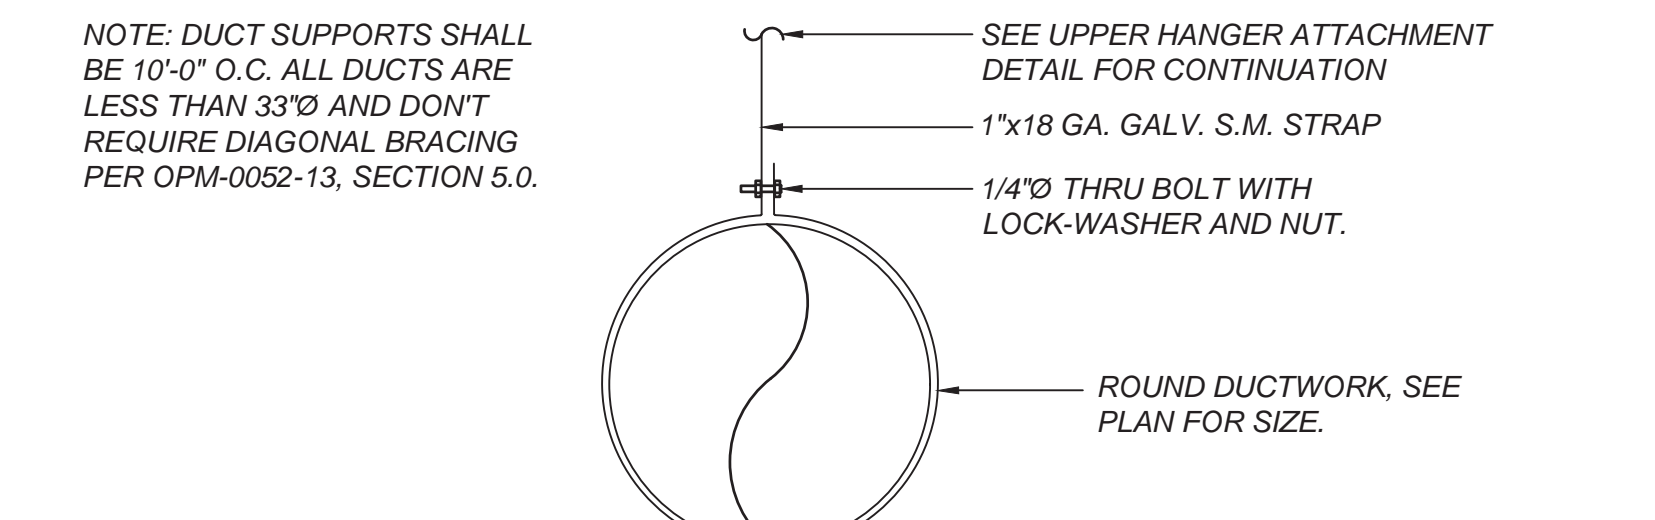

**ROUND DUCT HANGING DETAIL**  
SCALE: NONE

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Project no.: T80317  
File name: M105-M106 Mechanical Details


**Project:**  
THE COUNTY OF FRESNO  
DEPARTMENT OF BEHAVIORAL HEALTH  
OLIVE AVE CAMPUS REMODEL  
5555 E Olive Avenue, Fresno, California  
APN: 4522212ST  
Issue date: 2024-08-02  
Project no.: T80317  
File name: M105-M106 Mechanical Details

**Sheet Content:**  
**MECHANICAL DETAILS**


Fresno County Department of Public Works and Planning  
Capital Projects  
2220 Tulare Street, 8th Floor  
Fresno, California 93721

**Sheet No.:**  
**M-105**

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# MECHANICAL ROOF PLAN - OVERALL

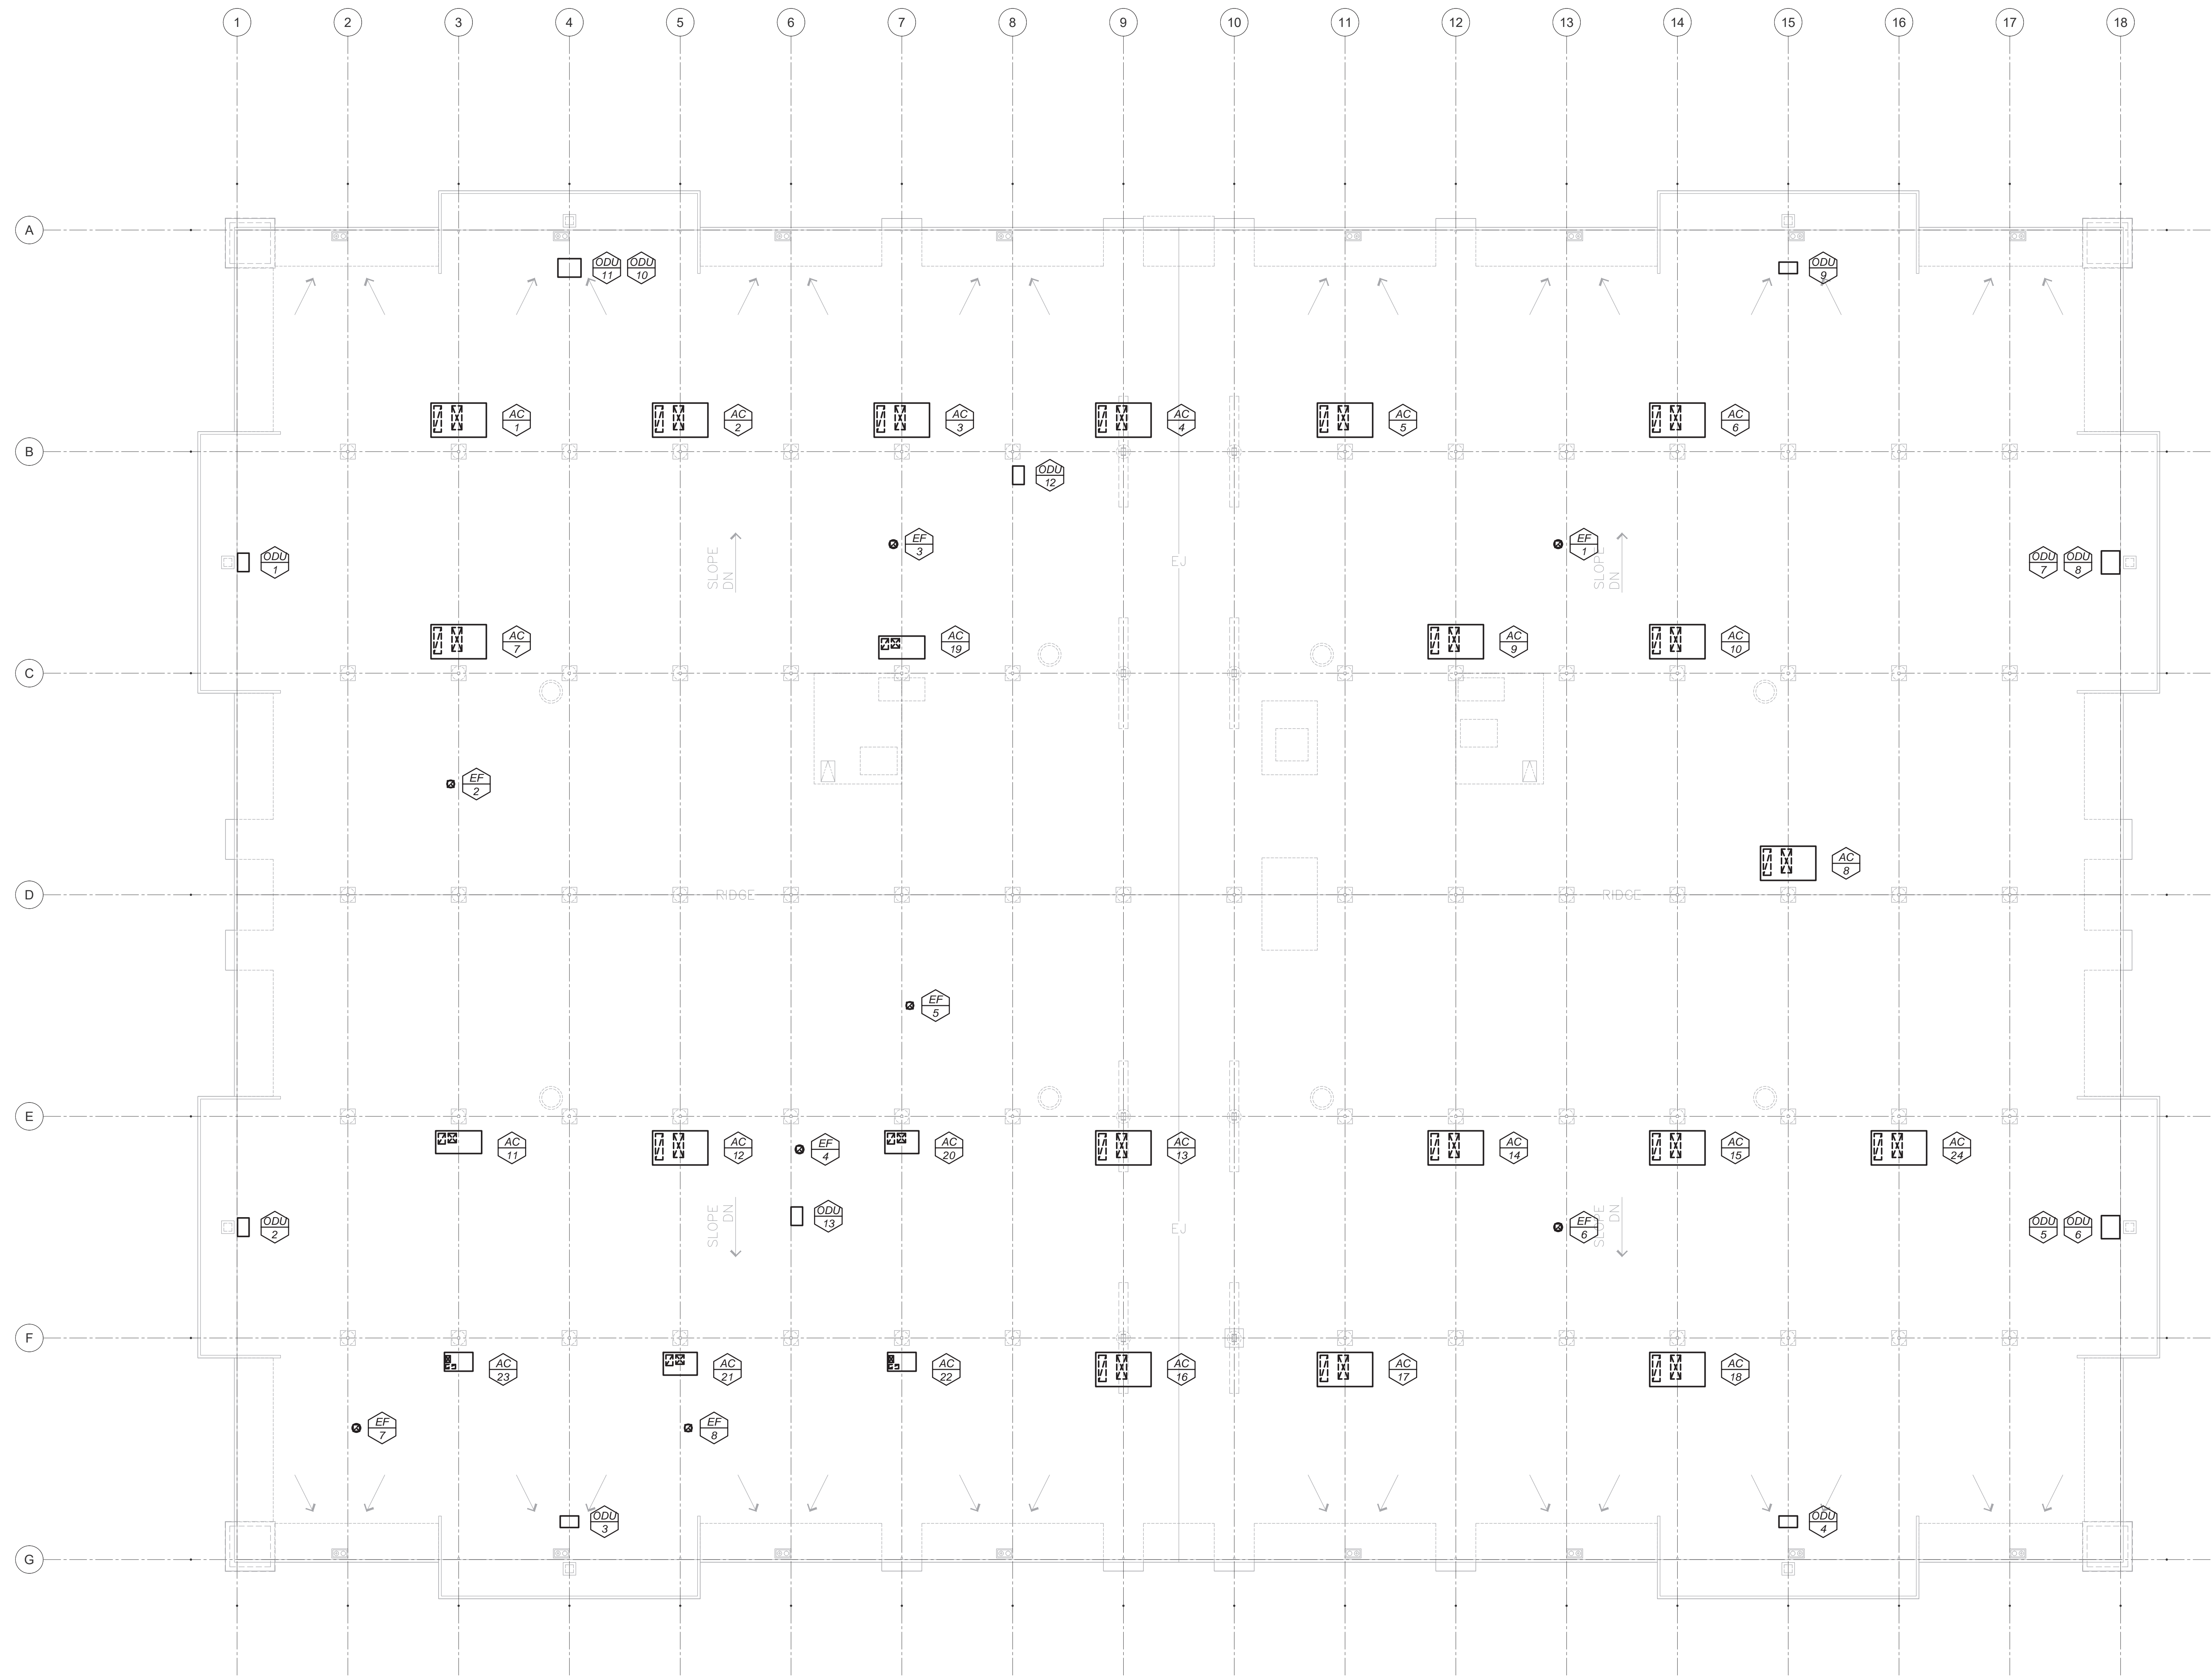Scale: 1/16" = 1'-0" 

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ENGINEERING GROUP  
#110 E. Clason Way, Suite 101, Fresno, CA 93727  
509-431-6161 24069 FAX 509-431-1342

**PRELIMINARY**  
NOT FOR CONSTRUCTION  
REVISION: 12-31-2023  
ARCHITECT:  
Barry Lynn Mack, Architect  
California License Architect No. C 38749  
Plan: 12-31-2023  
Fresno County Department of  
Public Works and Planning  
Development Services and  
Capital Projects Division  
2220 Tulare Street, 8th Floor  
Fresno, California 93721  
Office: (558) 400-4536  
Email: bmasi@fresnocountyca.gov

**Project:**  
THE COUNTY OF FRESNO  
DEPARTMENT OF BEHAVIORAL HEALTH  
OLIVE AVE CAMPUS REMODEL  
5555 E Olive Avenue, Fresno, California  
APN: 45522312ST  
Issue date: 2024-08-02  
Project no.: T80317  
File name: M300-M304 - Mechanical Roof Plan


**Sheet Content:**  
**MECHANICAL ROOF  
PLAN - OVERALL**

Fresno County Department of  
Public Works and Planning  
Capital Projects  
2220 Tulare Street, 8th Floor  
Fresno, California 93721 


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2 August 2024 12:18 PM P:\2024\24069 Fresno County Behavioral Health Remodel\Drawings\M300-M304 - Mechanical Roof Plan.dwg gony \*

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# MECHANICAL ROOF PLAN - AREA A

Scale: 1/8" = 1'-0" 
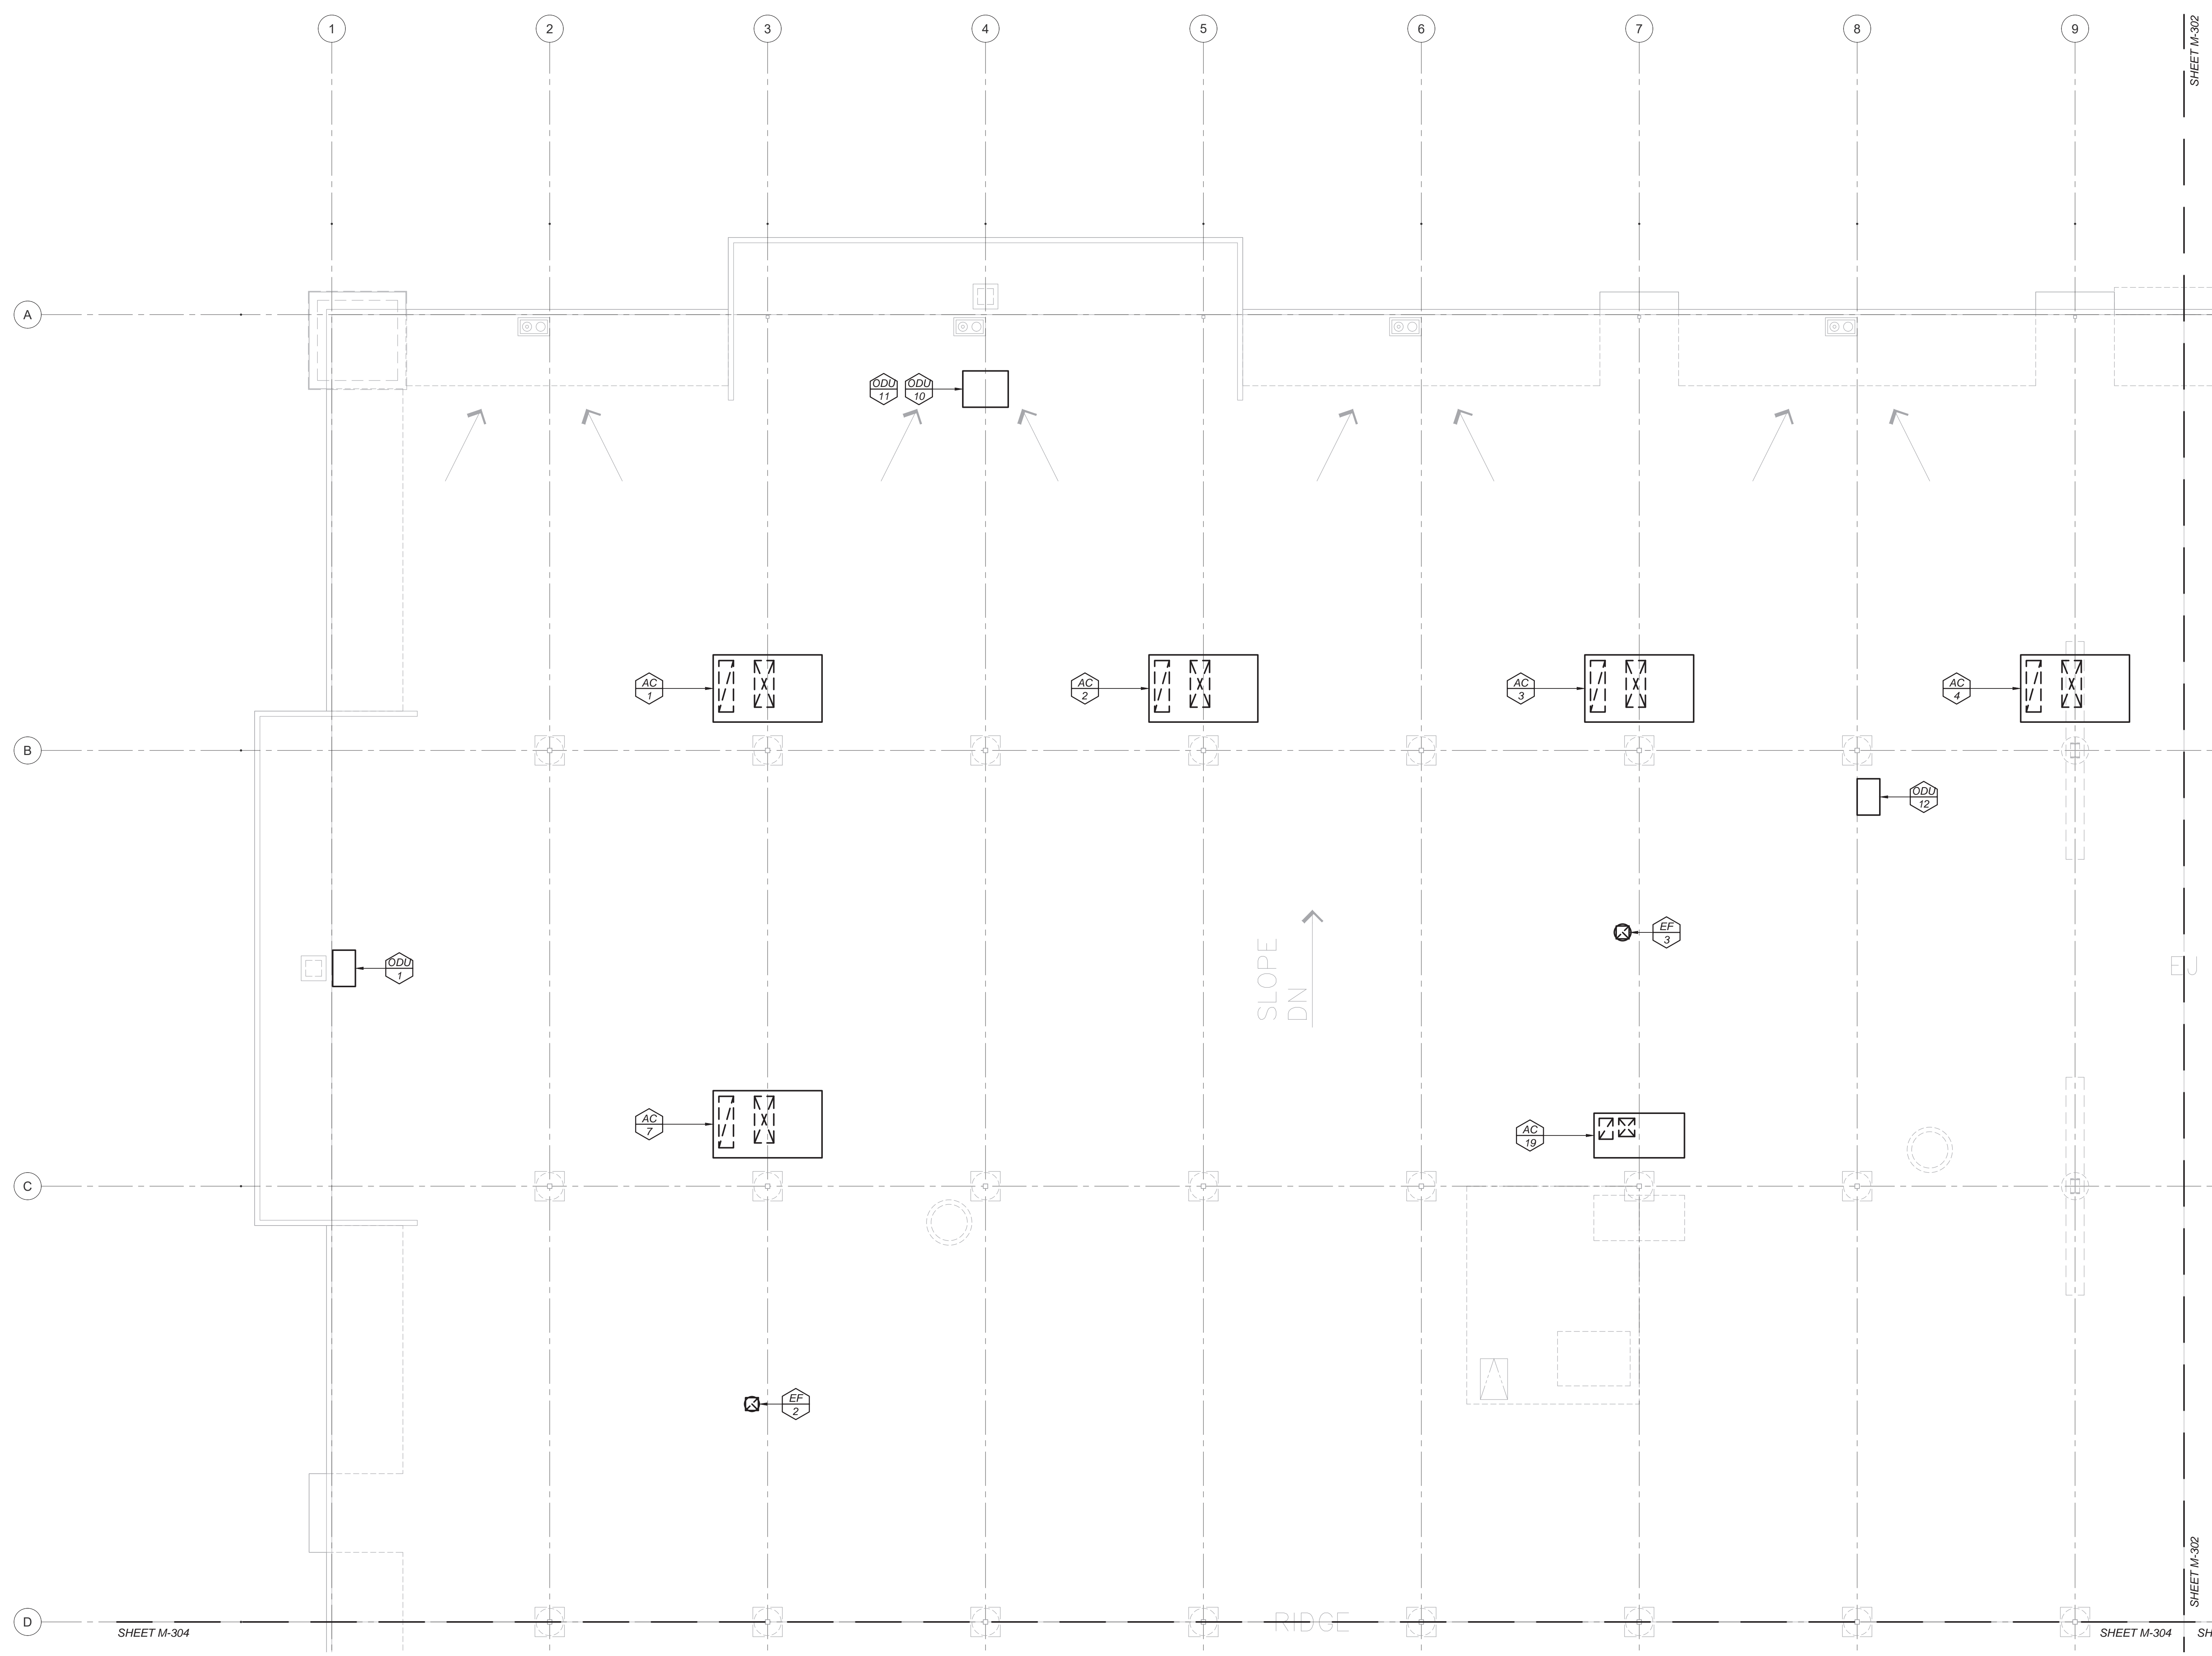
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ENGINEERING GROUP  
1910 E. Clifton Way, Suite 101, Fresno, CA 93727  
509-431-6161 24069 FAX 509-431-1342

REGISTERED PROFESSIONAL ENGINEER  
MICHAEL D. CARROLL  
No. M23588  
Exp. 9-30-25  
MECHANICAL  
STATE OF CALIFORNIA

ARCHITECT:  
BARRY LYNN MASON, ARCHITECT  
California License Architect No. C 38749  
Plan: 12-31-2025  
Fresno County Department of  
Public Works and Planning  
Development Services and  
Capital Projects Division  
2220 Tulare Street, 8th Floor  
Fresno, California 93721  
Office: (558) 400-4536  
Email: blynn@fresnocountyca.gov

REGISTERED ARCHITECT  
BARRY LYNN MASON  
PRELIMINARY  
NOT FOR CONSTRUCTION  
REVISION: 12-31-2025  
STATE OF CALIFORNIA

**Project:**  
THE COUNTY OF FRESNO  
DEPARTMENT OF BEHAVIORAL HEALTH  
OLIVE AVE CAMPUS REMODEL  
5555 E Olive Avenue, Fresno, California  
APN: 45522312ST  
Issue date: 2024-08-02  
Project no.: T80317  
File name: M300-M304 - Mechanical Roof Plan

**Sheet Content:**  
MECHANICAL ROOF  
PLAN - AREA A


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Capital Projects

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Fresno, California 93721



Sheet No.:  
**M-301**

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# MECHANICAL ROOF PLAN - AREA B

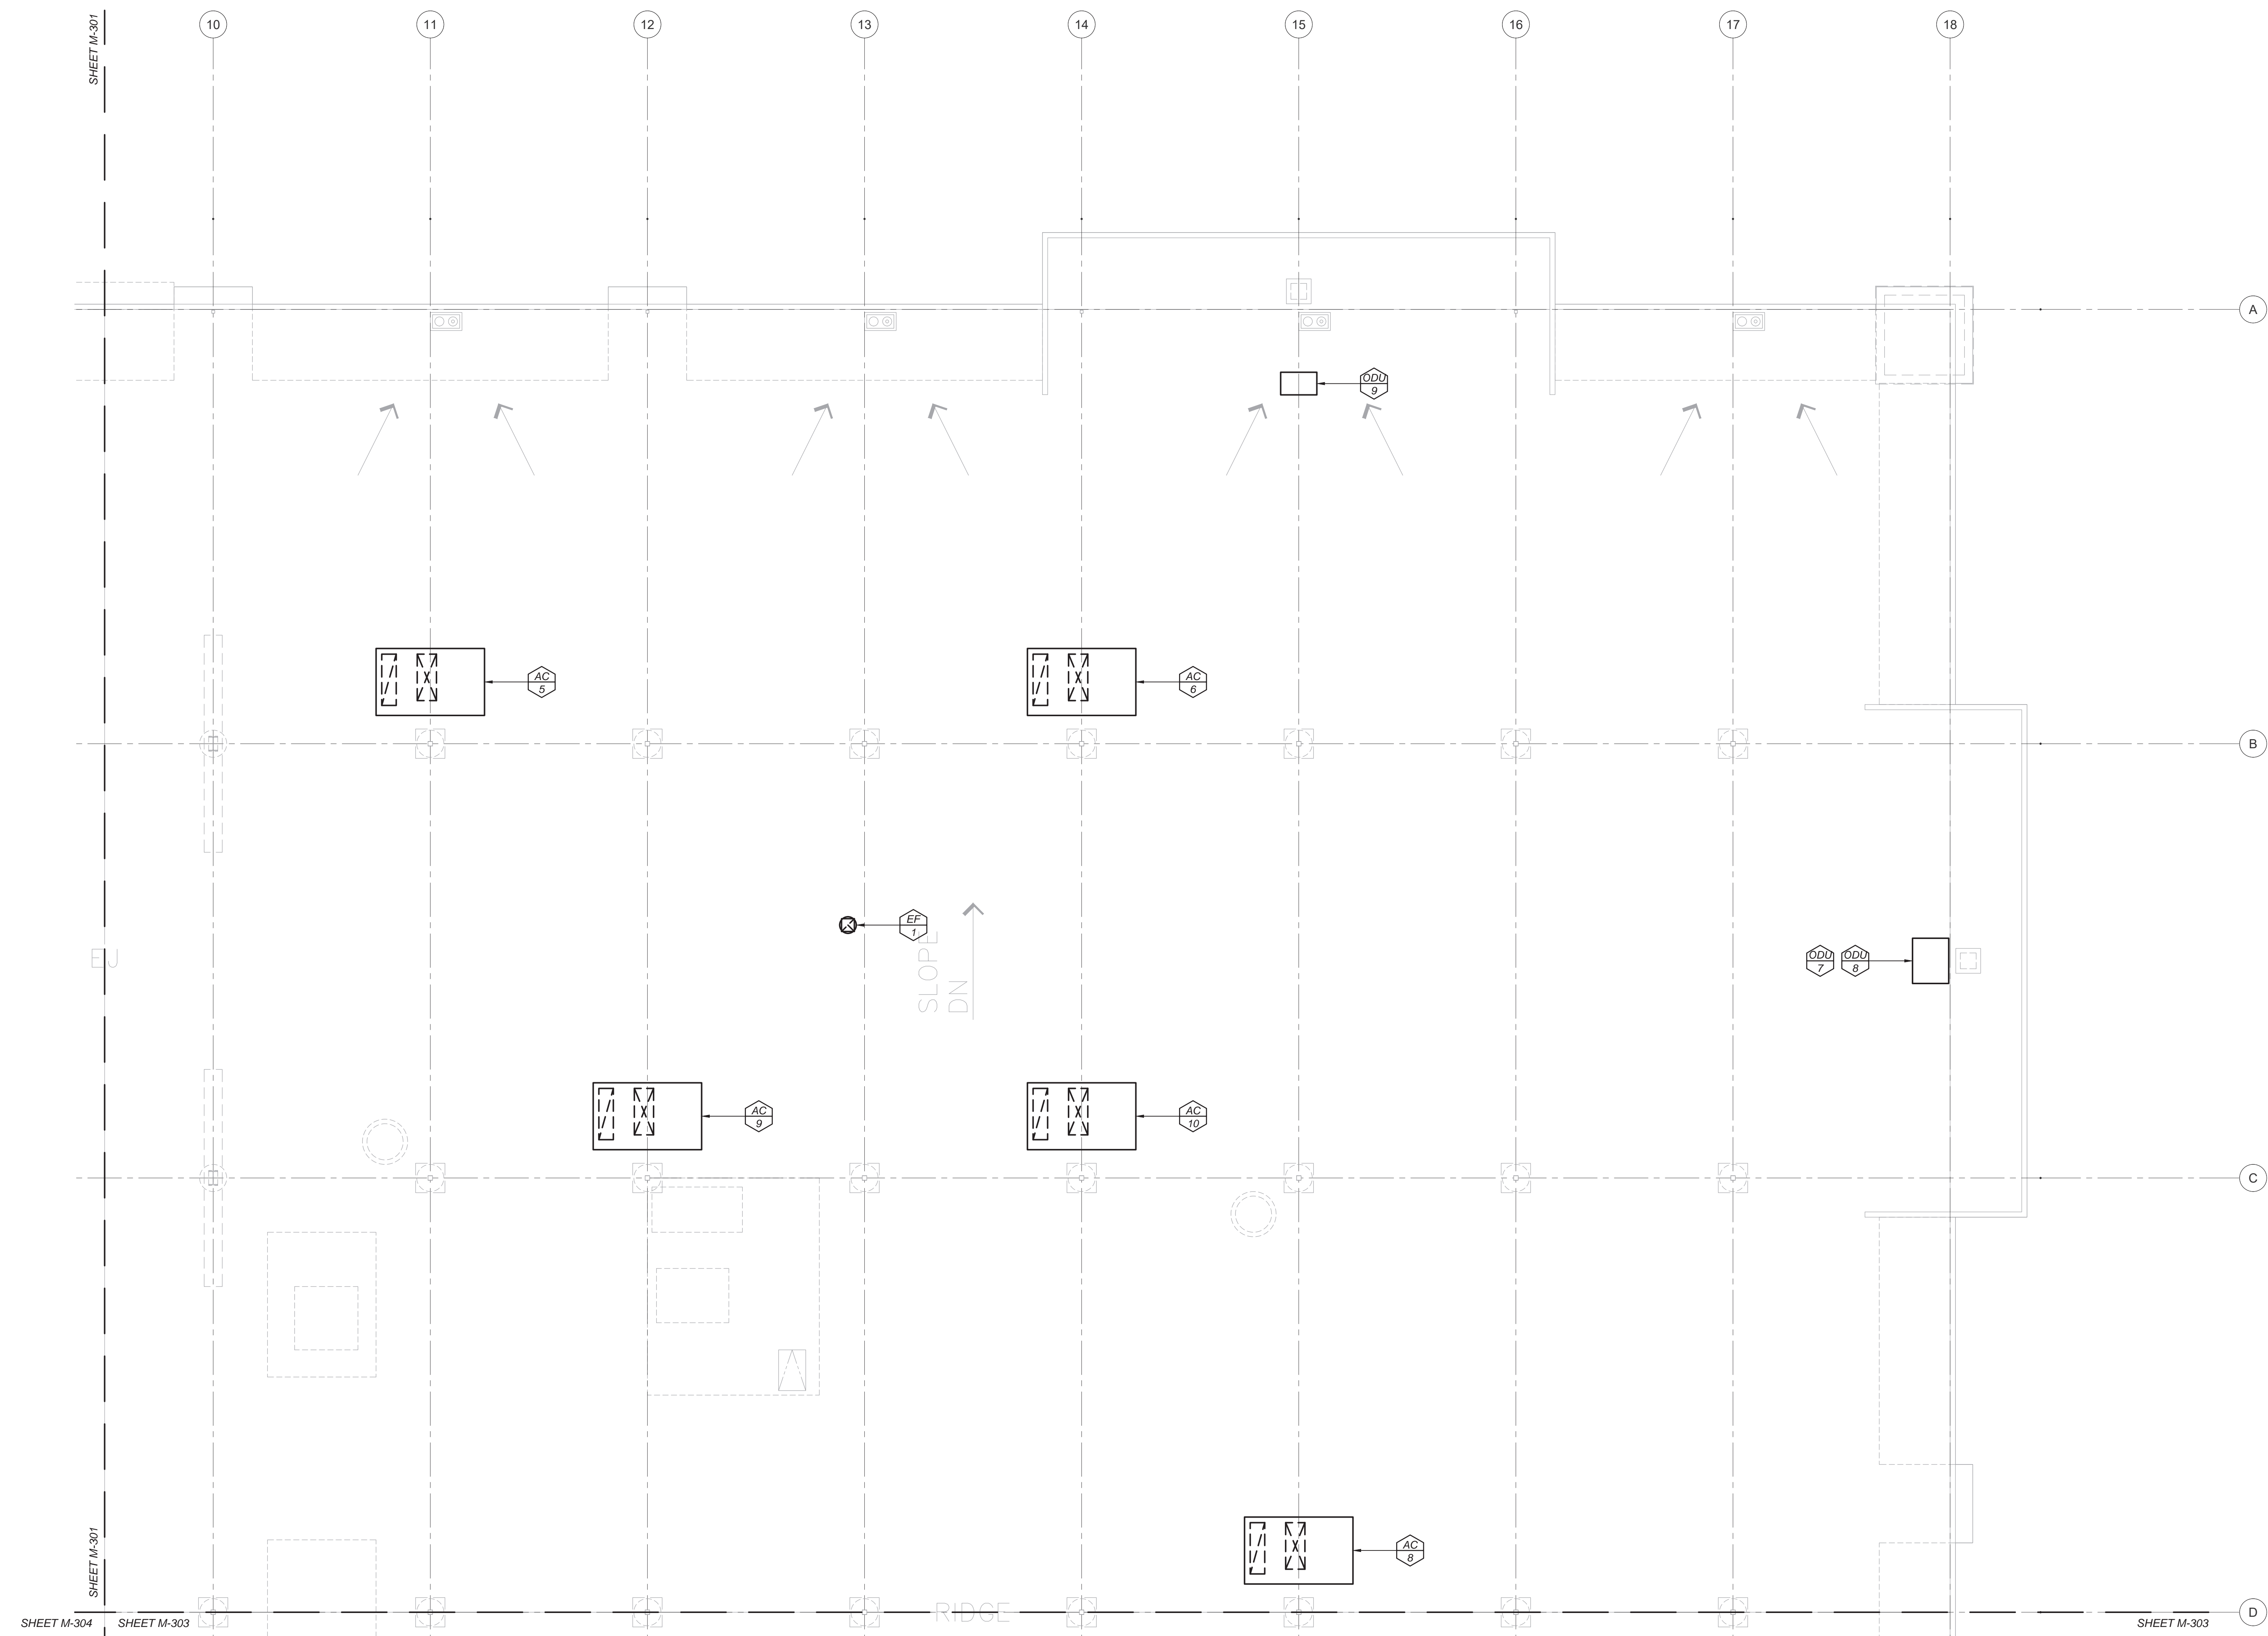Scale: 1/8" = 1'-0"



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ENGINEERING GROUP**

4110 E. Clarendon Way, Suite 101, Fresno, CA 93727  
509.431.6161 24069 FAX 509.431.1342

**PRELIMINARY**

**NOT FOR CONSTRUCTION**

ARCHITECT:  
Barry Lynn Mack, Architect  
California License Architect No. C 38749  
Plan: 12-31-2025  
Fresno County Department of  
Public Works and Planning  
Development Services and  
Capital Projects Division  
2220 Tulare Street, 8th Floor  
Fresno, California 93721  
Office: (558) 400-4536  
Email: bnmack@fresnocountyca.gov

**Project:**  
THE COUNTY OF FRESNO  
DEPARTMENT OF BEHAVIORAL HEALTH  
OLIVE AVE CAMPUS REMODEL  
5555 E Olive Avenue, Fresno, California  
APN: 45522312ST  
Issue date: 2024-08-02  
Project no.: T80317  
File name: M300-M304 - Mechanical Roof Plan


**Sheet Content:**  
MECHANICAL ROOF  
PLAN - AREA B

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Capital Projects

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Fresno, California 93721

Sheet No.:  
**M-302**

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ENGINEERING GROUP**

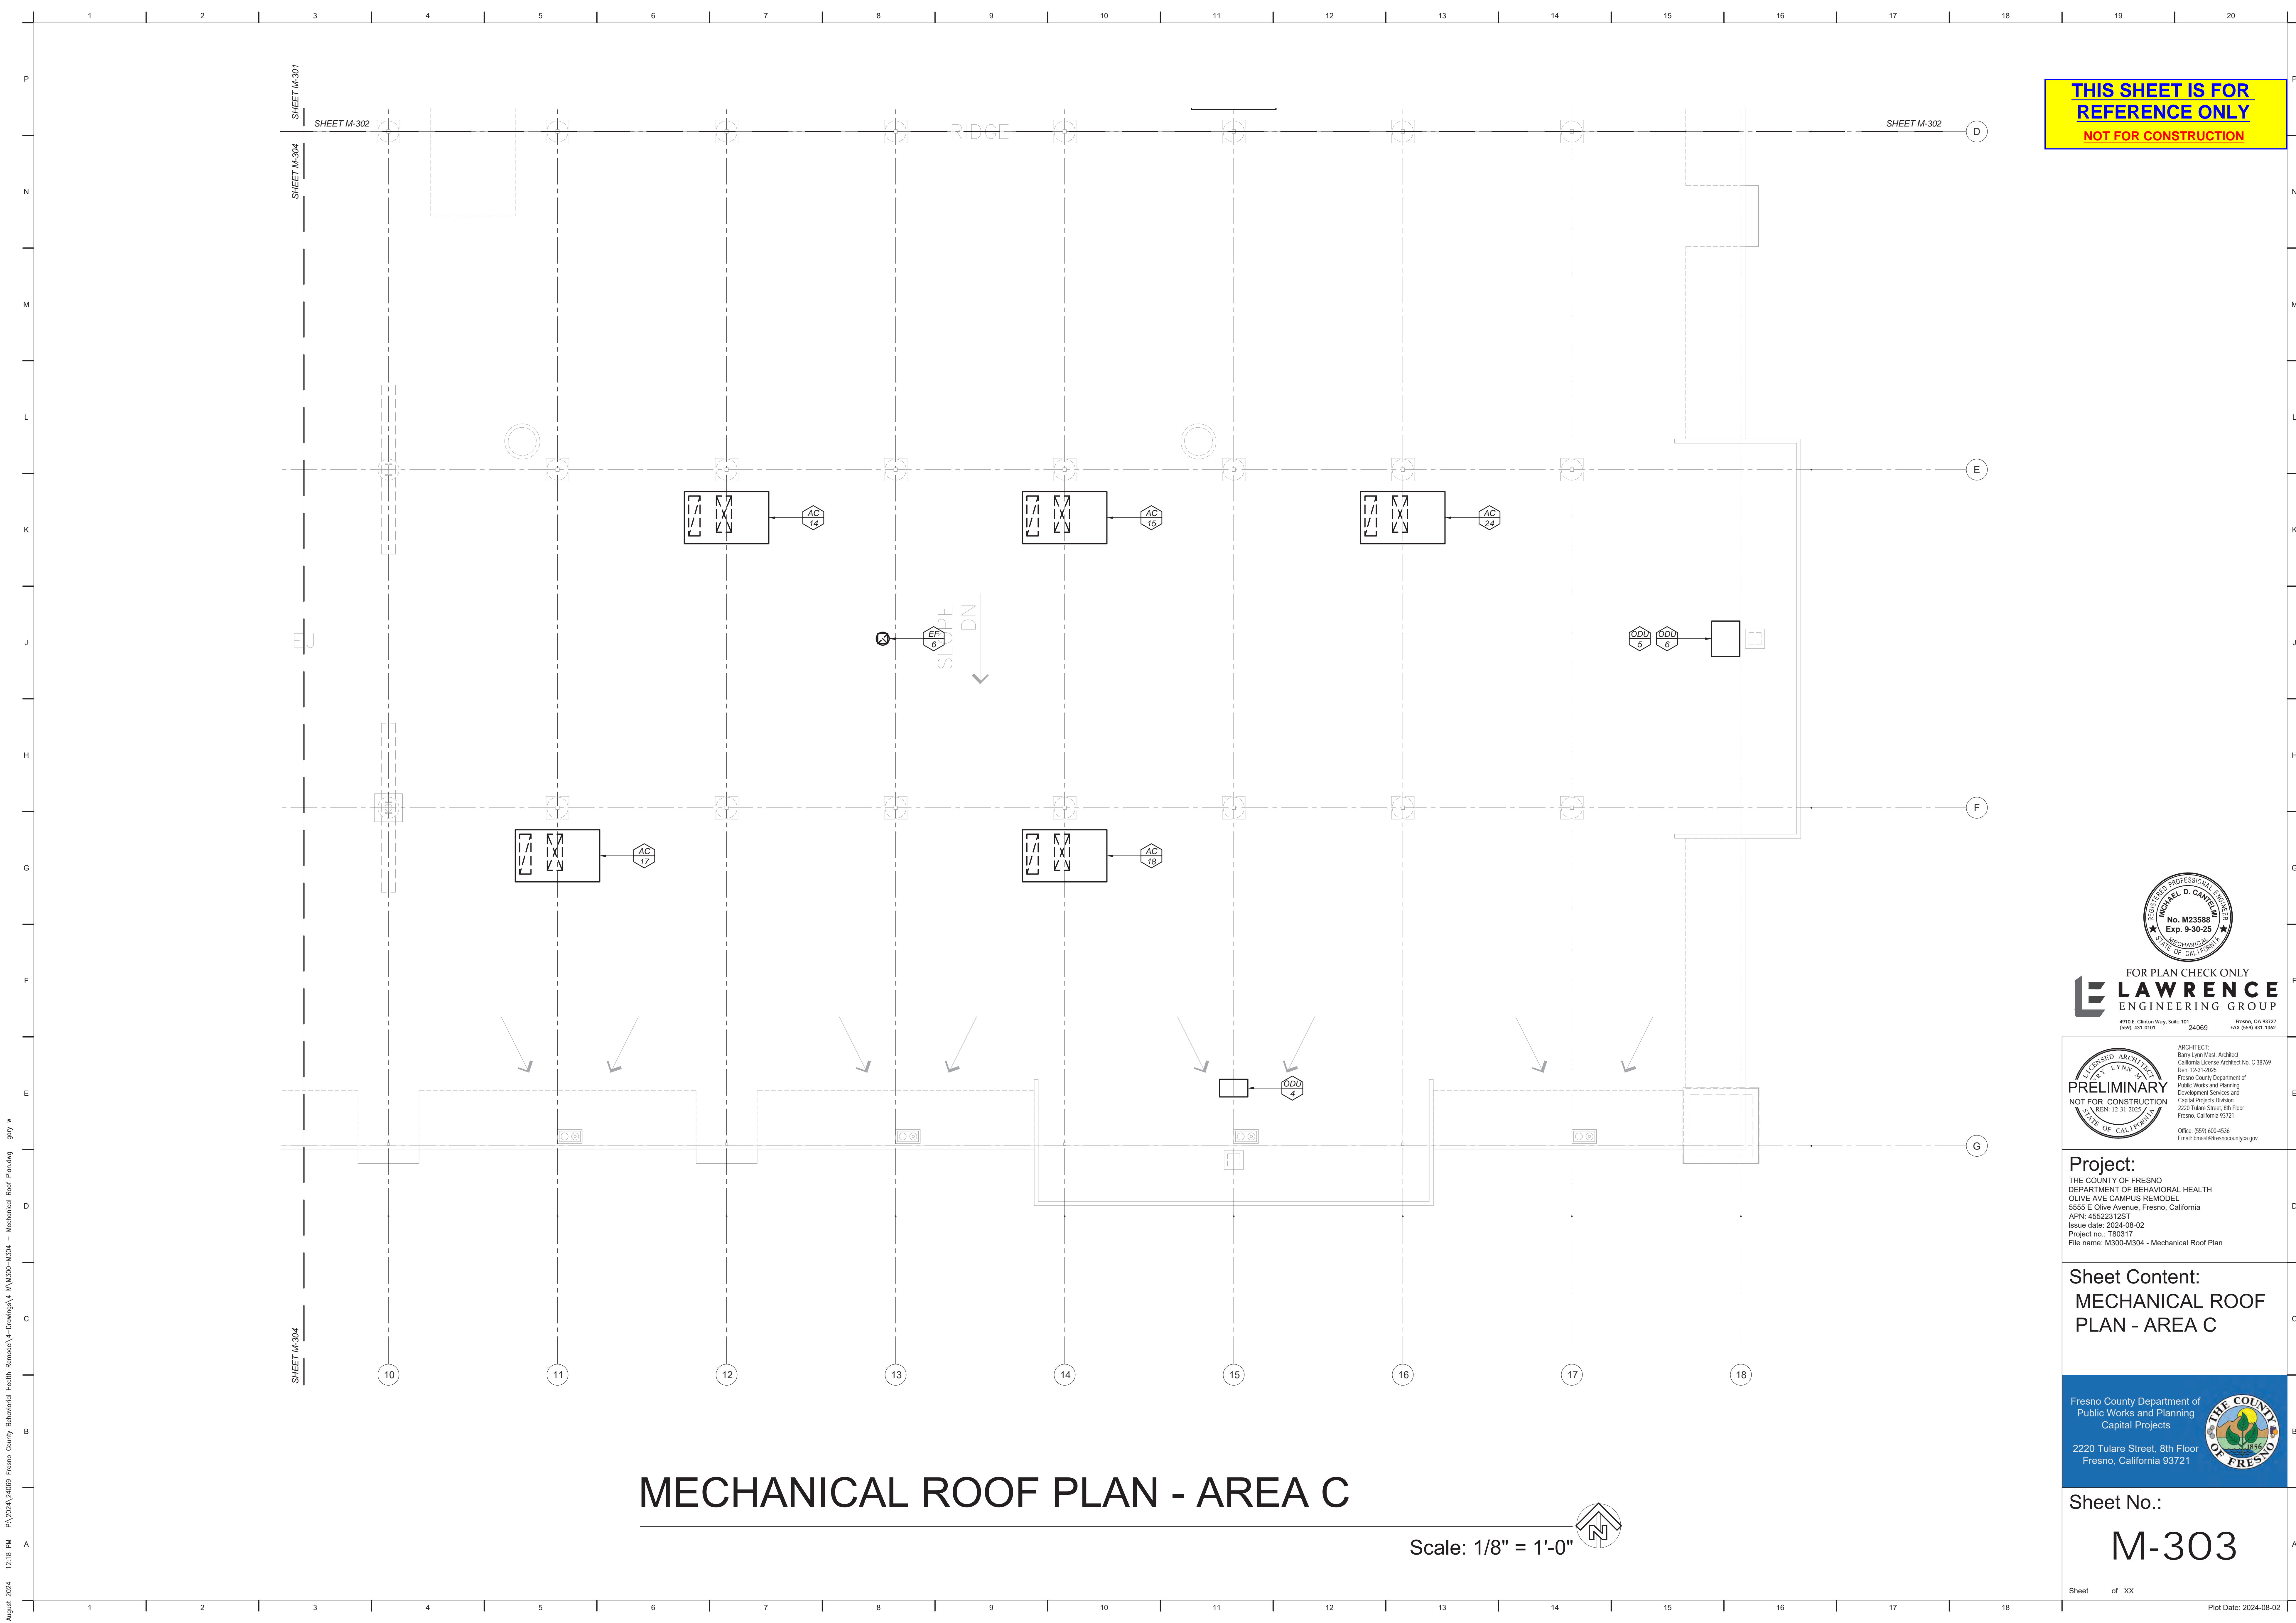ARCHITECT:  
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Plan: 12-31-2025  
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**Project:**  
THE COUNTY OF FRESNO  
DEPARTMENT OF BEHAVIORAL HEALTH  
OLIVE AVE CAMPUS REMODEL  
5555 E Olive Avenue, Fresno, California  
APN: 45522312ST  
Issue date: 2024-08-02  
Project no.: T80317  
File name: M300-M304 - Mechanical Roof Plan

**Sheet Content:**  
**MECHANICAL ROOF  
PLAN - AREA C**

Fresno County Department of  
Public Works and Planning  
Capital Projects  
2220 Tulare Street, 8th Floor  
Fresno, California 93721



Sheet No.:  
**M-303**


Sheet of XX  
Plot Date: 2024-08-02

# MECHANICAL ROOF PLAN - AREA C

Scale: 1/8" = 1'-0"



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**THIS SHEET IS FOR  
REFERENCE ONLY  
NOT FOR CONSTRUCTION**

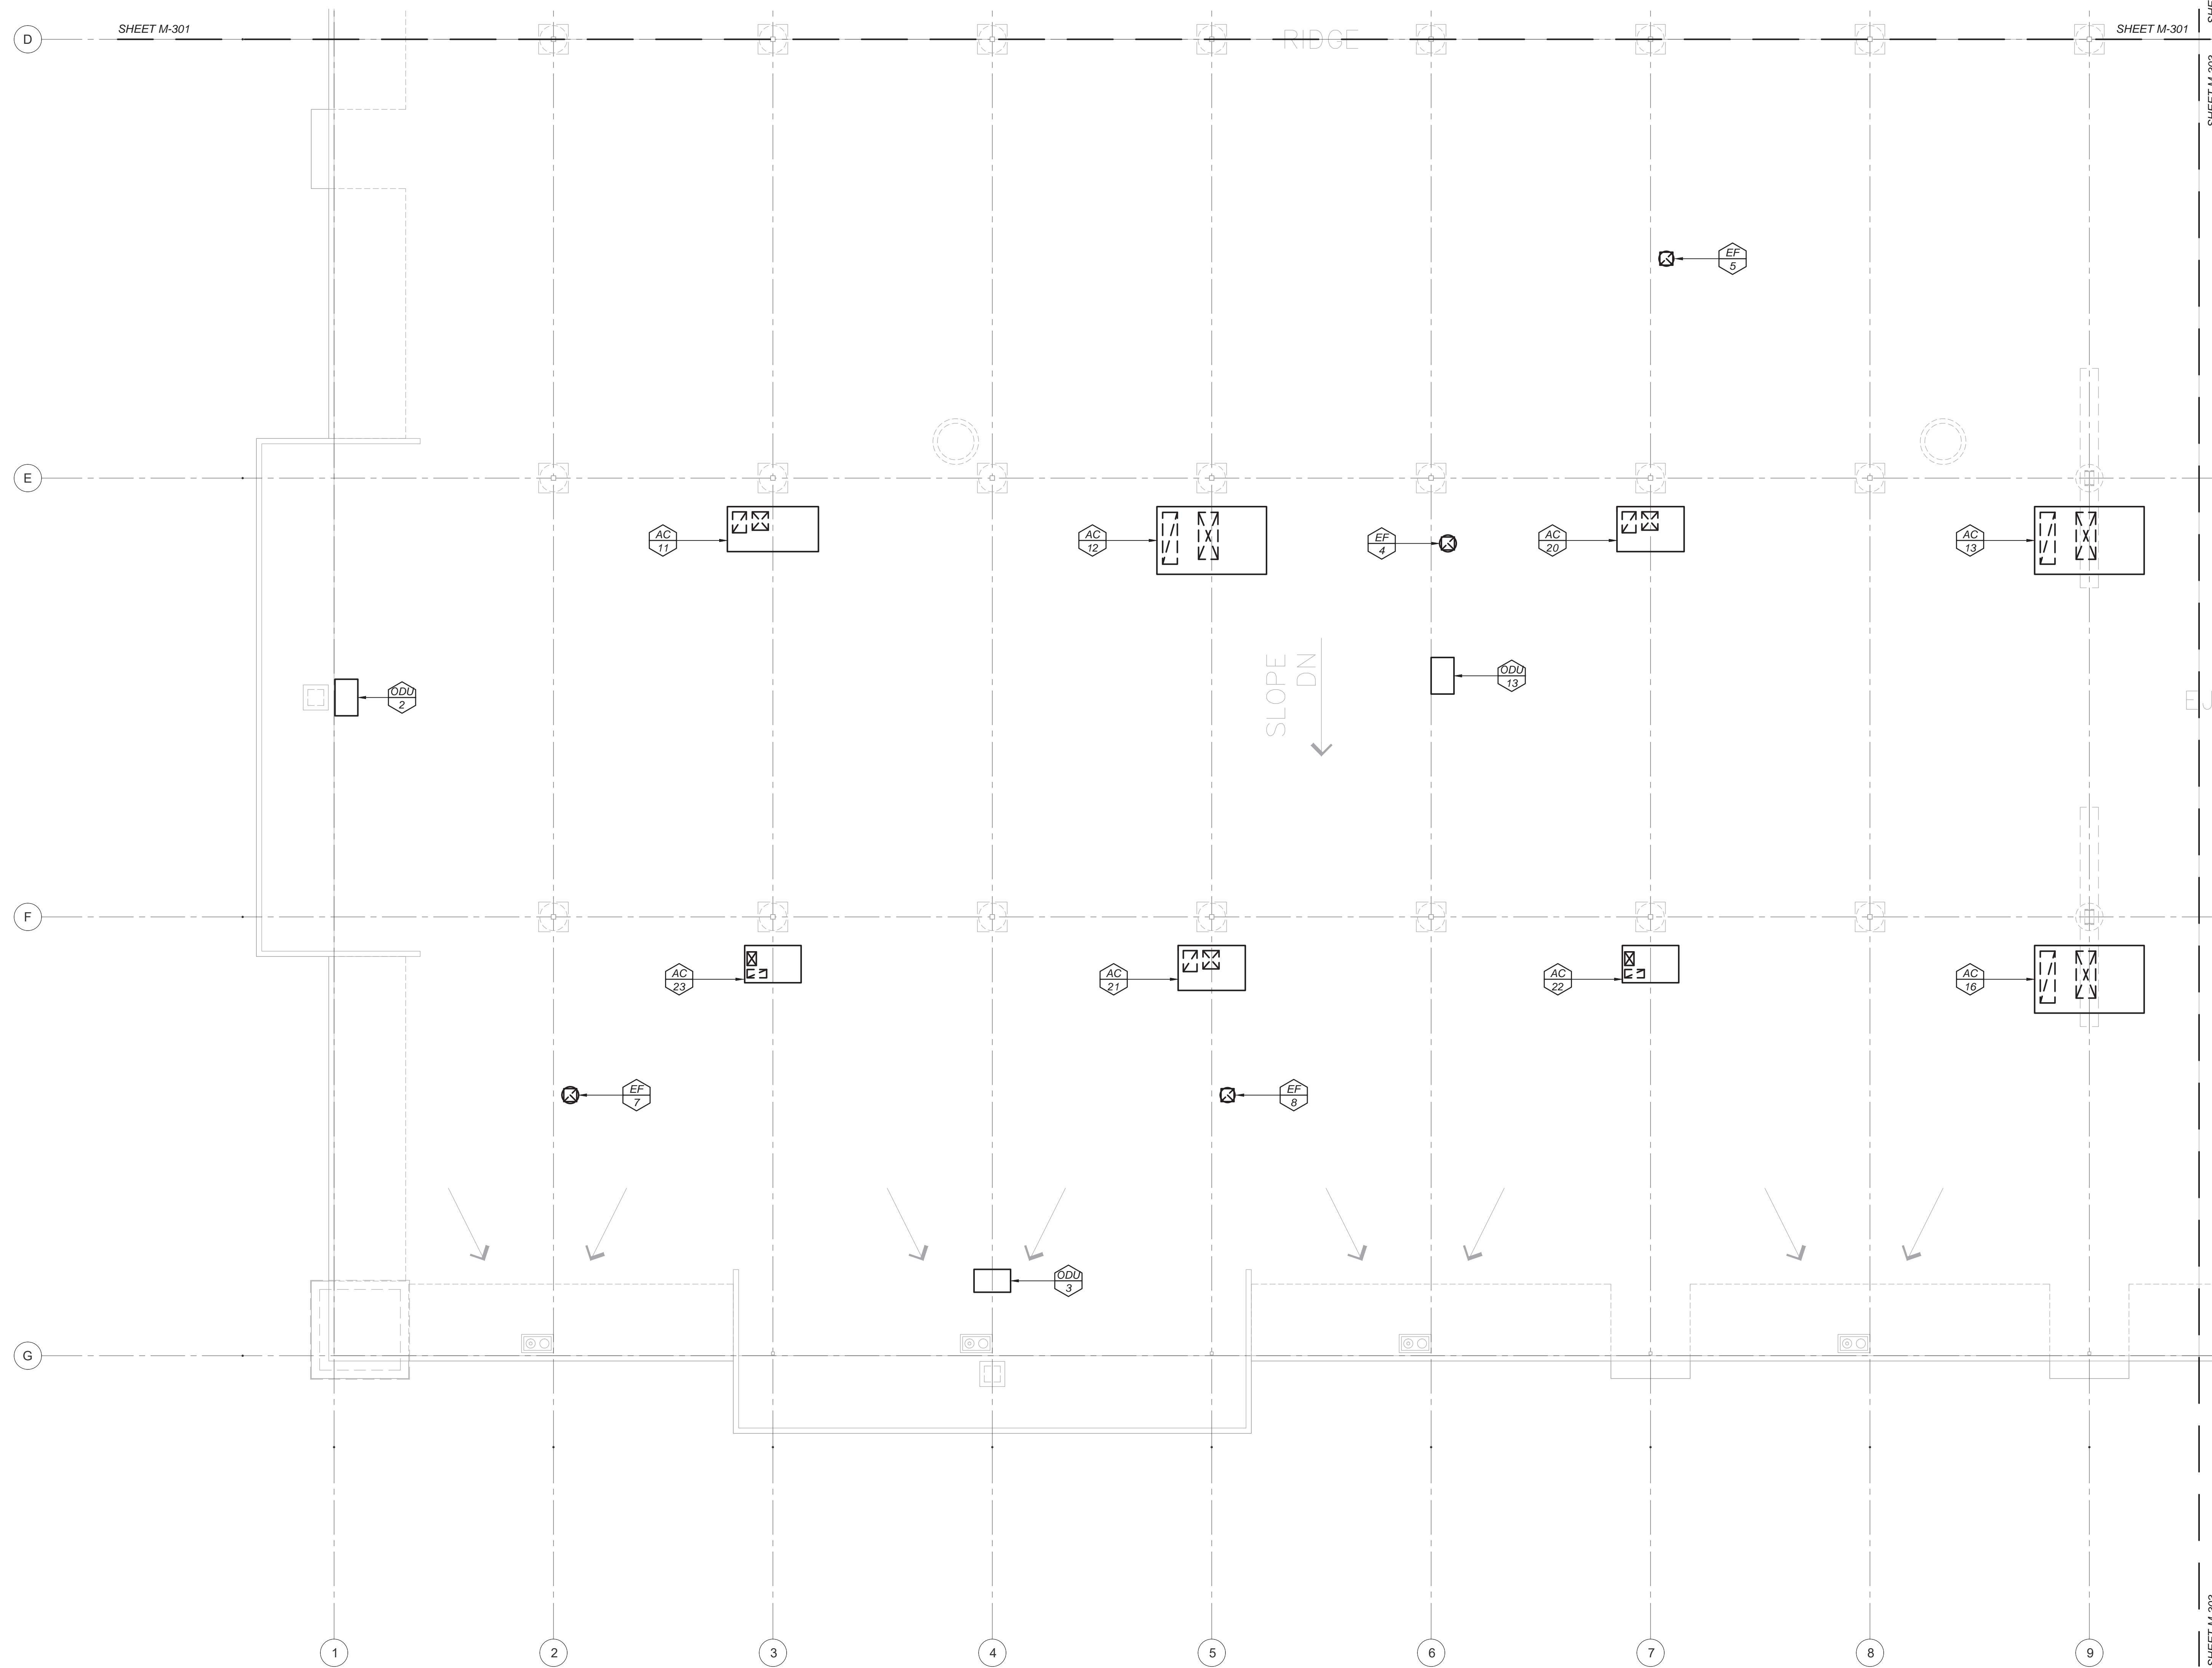FOR PLAN CHECK ONLY

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**PRELIMINARY**  
NOT FOR CONSTRUCTION  
REVISION: 12-31-2025  
STATE OF CALIFORNIA

**Project:**  
THE COUNTY OF FRESNO  
DEPARTMENT OF BEHAVIORAL HEALTH  
OLIVE AVE CAMPUS REMODEL  
5555 E Olive Avenue, Fresno, California  
APN: 45522312ST  
Issue date: 2024-08-02  
Project no.: T80317  
File name: M300-M304 - Mechanical Roof Plan

**Sheet Content:**  
MECHANICAL ROOF  
PLAN - AREA D

Fresno County Department of  
Public Works and Planning  
Capital Projects

2220 Tulare Street, 8th Floor  
Fresno, California 93721

Sheet No.:  
**M-304**

# MECHANICAL ROOF PLAN - AREA D

Scale: 1/8" = 1'-0"

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